

LIGHTING FIXTURE SCHEDULE			FIXTURE CATALOG NUMBER DOES NOT REFLECT TRIM OR FLANGE REQUIRED FOR A SPECIFIC CEILING TYPE IN A ROOM. CONTRACTOR SHALL VERIFY CEILING TYPES FROM ARCHITECTURAL DRAWINGS TO DETERMINE WHETHER FIXTURE REQUIRES TYPE G, F, PF, MT OR ST TRIM.			
TYPE	DESCRIPTION	MANUFACTURER	SERIES NUMBER	MOUNTING	(#) LAMPS LUMENS CRI, COLOR	NOTES
A AE	FULL BODY FLUORESCENT NOMINAL 16" X 4" HIGH BAY, WHITE FINISH, SPECULAR MIRROR REFLECTOR, TASK (NARROW) DISTRIBUTION, CLEAR ACRYLIC SHIELD, WIRE GUARD, DUAL STEM HUNG	LITHONIA METALLUX DAYBRITE COLUMBIA	F0B164-654T5H0-T1X20-ACL-WG HB1654T5-NCL1WG FBF-654H0-WG-FBF6/FBF-6E-1W LHV4-654-MAR-CA-WG	SUSPENDED 28'-0" TO BOTTOM, LEVEL WITH BOTTOM OF TRUSS	(6) F54T5H0 4450 82, 3500K	PROVIDE TWO ELECTRONIC BALLASTS WITH <10% THD. WHERE SUFFIX "E" INDICATED. EMERGENCY FIXTURE WITH A SINGLE BATTERY INVERTER FOR THREE LAMP OPERATION.
B BE	FULL BODY FLUORESCENT NOMINAL 16" X 4" HIGH BAY, WHITE FINISH, SPECULAR MIRROR REFLECTOR, TASK (NARROW) DISTRIBUTION, CLEAR ACRYLIC SHIELD, WIRE GUARD, DUAL STEM HUNG	LITHONIA METALLUX DAYBRITE COLUMBIA	F0B164-432-T1X20-ACL-WG HB1432-N-CL1WG FBF-432-WG-FBF4/FBF-4E-1W LHV4-432-MAR-CA-WG	SUSPENDED 12'-0" TO BOTTOM	(4) F32T8 2900 82, 3500K	PROVIDE TWO ELECTRONIC BALLASTS WITH <10% THD. WHERE SUFFIX "E" INDICATED. EMERGENCY FIXTURE WITH A SINGLE BATTERY INVERTER FOR TWO LAMP OPERATION.
C CE	NARROW PROFILE SURFACE FLUORESCENT WRAPAROUND, ACRYLIC PRISMATIC LENS	LITHONIA METALLUX DAYBRITE COLUMBIA	CA CR WB WB	CEILING OR WALL AS INDICATED	(2) F32T8 2900 82, 3500K	PROVIDE ELECTRONIC BALLAST WITH <10% THD. WHERE SUFFIX "E" INDICATED. EMERGENCY FIXTURE WITH A SINGLE BATTERY INVERTER FOR TWO LAMP OPERATION.
D DE	8"x4" FIBERGLASS HEAVY-DUTY FLUORESCENT ENCLOSED AND GASKETED, UL WET LOCATION LISTED	LITHONIA METALLUX DAYBRITE COLUMBIA	DMW-1-32 VT2 VW LUN	CEILING OR WALL AS INDICATED	(1) F32T8 2900 82, 3500K	PROVIDE ELECTRONIC BALLAST WITH <10% THD. WHERE SUFFIX "E" INDICATED. EMERGENCY FIXTURE WITH A SINGLE BATTERY INVERTER FOR TWO LAMP OPERATION.
F FE	HEAVY DUTY FLUORESCENT INDUSTRIAL, 10% UPLIGHT, CHAIN HUNG	LITHONIA METALLUX DAYBRITE COLUMBIA	AF10 DM 1F KL	SUSPENDED 10'-0" AFF	(2) F32T8 2900 82, 3500K	PROVIDE ELECTRONIC BALLAST WITH <10% THD. WHERE SUFFIX "E" INDICATED. EMERGENCY FIXTURE WITH A SINGLE BATTERY INVERTER FOR TWO LAMP OPERATION.
G GE	2"x4" FLUORESCENT, WHITE STEEL FRAME, .125 A12 ACRYLIC PRISMATIC LENS, 2 LAMP	LITHONIA METALLUX DAYBRITE COLUMBIA	2SP8 2G08 TG8 ST8	RECESSED	(2) F32T8 2900 82, 3500K	PROVIDE ELECTRONIC BALLAST WITH <10% THD. WHERE SUFFIX "E" INDICATED. EMERGENCY FIXTURE WITH A SINGLE BATTERY INVERTER FOR TWO LAMP OPERATION.
G2 G2E	2"x2" FLUORESCENT, WHITE STEEL FRAME, .125 A12 ACRYLIC PRISMATIC LENS, 2 LAMP	LITHONIA METALLUX DAYBRITE COLUMBIA	2SP8 2G08 TG8 ST8	RECESSED	(2) F31T8U 2900 82, 3500K	PROVIDE ELECTRONIC BALLAST WITH <10% THD. WHERE SUFFIX "E" INDICATED. EMERGENCY FIXTURE WITH A SINGLE BATTERY INVERTER FOR TWO LAMP OPERATION.
H HD HE HDE	8" APERTURE COMPACT FLUORESCENT OPEN DOWNLIGHT, VERTICAL LAMP, SPECULAR LOW IRIDESCENT, CLEAR TRIM	GOTHAM PORTFOLIO OMEGA PRESCOLITE	AFV8 CT032 OM8 CFT8	RECESSED	(1) CFT832 2400 82, 3500K	PROVIDE ELECTRONIC BALLAST WITH <10% THD. WHERE SUFFIX "E" INDICATED. EMERGENCY FIXTURE WITH A SINGLE BATTERY INVERTER. "D" SUFFIX INDICATES DIMMING BALLAST.
H1	6" APERTURE COMPACT FLUORESCENT WET LOCATION SHOWER DOWNLIGHT, VERTICAL LAMP, FRESNEL LENS, WHITE SPLAY TRIM	LITHONIA HALO	LPRFN-26TRT-6LR4 P06V142-60V4G0F FV28-V08F	RECESSED	(1) CFT826 1800 82, 3500K	PROVIDE ELECTRONIC BALLAST WITH <10% THD.
J JE	2"x4" FLUORESCENT VOLUMETRIC, WHITE STEEL FRAME, ACRYLIC PRISMATIC LENS, 2 LAMP	LITHONIA METALLUX DAYBRITE COLUMBIA	2RT8S-232 2AC-232 2ATNG-232 EPC2G-SH	RECESSED	(2) F32T8 2900 82, 3500K	PROVIDE ELECTRONIC BALLAST WITH <10% THD. WHERE SUFFIX "E" INDICATED. EMERGENCY FIXTURE WITH A SINGLE BATTERY INVERTER FOR TWO LAMP OPERATION.
K	16" SQUARE RECESSED HID DOWNLIGHT WITH 150W HPS LAMP, FLAT FRESNEL GLASS LENS, UL WET LOCATION LISTED	BETA HUBBELL FAILSAFE	BOP-S16-H-C7-1L-150 HPS-MT ST-S15-VLSYFGP HBRVIMP	RECESSED	(1) 150 HPS 16000 22, 2300K	
L	10" SQUARE RECESSED HID DOWNLIGHT WITH 70W PULSE START MH LAMP, FLAT ALBALITE LENS, UL WET LOCATION LISTED	CAPRI PRESCOLITE HALO	C4H10IM70-SS3P LHFSQL-H10-70MH M200T730	RECESSED	(1) 70 PSMH 4700 70, 4000K	
M	APRON HID FLOODLIGHTS WITH PRECISION CURVED REFLECTOR, INTERNAL LOUVER BLADES, ONE PIECE ALUMINUM HOUSING, HORIZONTAL SITE CUTOFF DISTRIBUTION (7X8), SLIPFITTER MOUNT	DAYBRITE LITHONIA MCGRAW-EDISON	FSL-10XS-ISF-MT-HSC TO MATCH EXISTING BLDG D 95V-RWW-480 ALF-F-1000HPS480-67	POLE MOUNTED	(1) 1000 HPS 130000 22, 2100K	MOUNT FIXTURES TO 5" DIAMETER, 30 FT TALL STRAIGHT ROUND STEEL POLE WITH BULLHORN BRACKET ASSEMBLY AND NUMBER OF FIXTURES AS INDICATED ON LIGHTING PLANS. POLE SHALL BE ATTACHED TO BUILDING WALL PER STRUCTURAL DETAIL.
MA	APRON HID FLOODLIGHTS WITH PRECISION CURVED REFLECTOR, INTERNAL LOUVER BLADES, ONE PIECE ALUMINUM HOUSING, HORIZONTAL SITE CUTOFF DISTRIBUTION (7X8), SLIPFITTER MOUNT	DAYBRITE LITHONIA MCGRAW-EDISON	FSL-10XS-ISF-MT-HSC TO MATCH EXISTING BLDG D 95V-RWW-480 ALF-F-1000HPS480-67	POLE MOUNTED	(1) 1000 HPS 130000 22, 2100K	MOUNT FIXTURES TO 9" DIAMETER, 50 FT TALL TAPERED ROUND STEEL POLE WITH BULLHORN BRACKET ASSEMBLY AND NUMBER OF FIXTURES AS INDICATED ON LIGHTING PLANS. POLE SHALL BE ATTACHED TO CONCRETE BASE
N	LED CUT-OFF WALL PACK WITH DIE CAST HOUSING, TEMPERED GLASS LENS, TYPE III DISTRIBUTION	LITHONIA	WST-LED2-10A70040K-SR3	WALL 12'-0" AFG	20 LED's 3040T 67, 5000K 47 INPUT WATTS	BASIS OF DESIGN AS SCHEDULED, BASED UPON PHOTOMETRIC PERFORMANCE AND APPEARANCE. ALSO ACCEPTABLE: LUMARK, DAYBRITE, KIM, GARDOO
P PE	WALL MOUNTED FIXTURE OVER MIRROR, STEEL HOUSING, ACRYLIC LENS, UP/DOWN LIGHT, WHITE FINISH	LITHONIA METALLUX DAYBRITE COLUMBIA	WP-132 BEU-132 CB-132 SA4-132	WALL AS NOTED	(1) F32T8 2900 82, 3500K	PROVIDE ELECTRONIC BALLAST WITH <10% THD. WHERE SUFFIX "E" INDICATED. EMERGENCY FIXTURE WITH A SINGLE BATTERY INVERTER.
R	EXTERIOR WALL MOUNTED 18" X 36" LED SHOEBOX, DIE-FORMED HOUSING, 700MA DRIVE CURRENT, TEMPERED GLASS LENS, FORWARD THROW DISTRIBUTION, DARK BRONZE COLOR	LITHONIA	CSX2LED 120C-700/50K 1TFM	WALL 30'-0" AFG	120 LED's 39649 67, 5000K 268 INPUT WATTS	BASIS OF DESIGN AS SCHEDULED, BASED UPON PHOTOMETRIC PERFORMANCE AND APPEARANCE. ALSO ACCEPTABLE: LUMARK, DAYBRITE, KIM, GARDOO
SA4	POLE MOUNTED 18" X 36" LED SHOEBOX, DIE-FORMED HOUSING, TEMPERED GLASS LENS, 1000MA DRIVE CURRENT, TYPE IV DISTRIBUTION, DARK BRONZE COLOR	LITHONIA	CSX2LED 120C-1000/50K 14M	40'-0" TALL, 6" SQUARE STEEL POLE	120 LED's 39649 67, 5000K 416 INPUT WATTS	BASIS OF DESIGN AS SCHEDULED, BASED UPON PHOTOMETRIC PERFORMANCE AND APPEARANCE. ALSO ACCEPTABLE: LUMARK, DAYBRITE, KIM, GARDOO
SAF	POLE MOUNTED 18" X 36" LED SHOEBOX, DIE-FORMED HOUSING, TEMPERED GLASS LENS, 1000MA DRIVE CURRENT, FORWARD THROW DISTRIBUTION, DARK BRONZE COLOR	LITHONIA	CSX2LED 120C-1000/50K 1TFM	30'-0" TALL, 6" SQUARE STEEL POLE	120 LED's 39649 67, 5000K 416 INPUT WATTS	BASIS OF DESIGN AS SCHEDULED, BASED UPON PHOTOMETRIC PERFORMANCE AND APPEARANCE. ALSO ACCEPTABLE: LUMARK, DAYBRITE, KIM, GARDOO
SB3	POLE MOUNTED 18" X 36" LED SHOEBOX, DIE-FORMED HOUSING, TEMPERED GLASS LENS, 700MA DRIVE CURRENT, TYPE III DISTRIBUTION, DARK BRONZE COLOR	LITHONIA	CSX2LED 120C-700/50K 13M	30'-0" TALL, 6" SQUARE STEEL POLE	120 LED's 28997 67, 5000K 268 INPUT WATTS	BASIS OF DESIGN AS SCHEDULED, BASED UPON PHOTOMETRIC PERFORMANCE AND APPEARANCE. ALSO ACCEPTABLE: LUMARK, DAYBRITE, KIM, GARDOO
SB4	POLE MOUNTED 18" X 36" LED SHOEBOX, DIE-FORMED HOUSING, TEMPERED GLASS LENS, 700MA DRIVE CURRENT, TYPE IV DISTRIBUTION, DARK BRONZE COLOR	LITHONIA	CSX2LED 120C-700/50K 14M	30'-0" TALL, 6" SQUARE STEEL POLE	120 LED's 29792 67, 5000K 268 INPUT WATTS	BASIS OF DESIGN AS SCHEDULED, BASED UPON PHOTOMETRIC PERFORMANCE AND APPEARANCE. ALSO ACCEPTABLE: LUMARK, DAYBRITE, KIM, GARDOO
X	UNIVERSAL MOUNT SELF POWERED LED EXIT SIGN, RED LETTERS, WHITE THERMOPLASTIC STENOIL FACE, Ni-CAD BATTERY	LITHONIA SURE-LITE MCPHILBEN DUAL-LITE	LQMSW-ELN LPX7 CXOL-3RG LXURWE	WALL OR CEILING AS INDICATED	LED (INCLUDED)	SINGLE OR DOUBLE FACE WITH OR WITHOUT DIRECTIONAL ARROWS, AS INDICATED.

GENERAL NOTES:

1. METHODS, MATERIALS AND PROVISIONS OF DIVISIONS 26, 27 AND 28 SPECIFICATIONS, GENERAL CONDITIONS AND DIVISION 1 SPECIFICATION SECTIONS ARE AN INTEGRAL PART OF THE BID AND CONSTRUCTION DOCUMENTS AND MUST BE RIGIDLY ADHERED TO.

2. PERFORM ALL WORK IN ACCORDANCE WITH THE 2011 EDITION OF THE NATIONAL ELECTRICAL CODE. IN SOME CASES, PROJECT DRAWINGS AND SPECIFICATIONS EXCEED MINIMUM CODE REQUIREMENTS.

3. ALL WIRE AND CABLE SHALL BE COPPER WITH THWN/THHN, 600 VOLT INSULATION. MINIMUM CONDUIT SIZE SHALL BE #12 FOR POWER AND LIGHTING CIRCUITS. MINIMUM CONDUCTOR SIZE SHALL BE #14 FOR SIGNAL/CONTROL CIRCUITS. BRANCH & FEEDER ABOVE THWN (90° C), SECONDARY SERVICE ENTRANCE – THWN (90° C).

4. #10 AND SMALLER WIRE CONNECTORS SHALL BE 600 VOLT ELECTRICAL SPRING CONNECTORS (IDEAL 451/452 OR 3M E12/512). #8 AND LARGER WIRE CONNECTORS SHALL BE THE SPLIT BOLT TYPE WITH INSULATION OF VINYL PLASTIC PADS AND VINYL PLASTIC TAPE (3M 2200/2210 AND SUPER 33+).

5. ALL WIRE AND CABLE SHALL BE INSTALLED IN CONDUIT. MINIMUM CONDUIT SIZE SHALL BE 3/4". MINIMUM BRANCH CIRCUIT HOMERUN CONDUIT SIZE SHALL BE 3/4".

6. ELECTRICAL METALLIC TUBING (EMT) WITH COMPRESSION COUPLINGS AND FITTINGS MAY BE USED IN FINISHED AREAS. EMT MAY ALSO BE USED IN UNFINISHED AREAS WHERE PROTECTED IN COLUMN WEBS OR UP IN JOIST SPACE.

7. PROVIDE RIGID GALVANIZED STEEL CONDUIT (RGSC) WHERE CONDUIT IS SUSCEPTIBLE TO PHYSICAL DAMAGE AND IN ALL EXTERIOR LOCATIONS ABOVE GROUND.

8. PROVIDE STEEL BONDING-TYPE LOCKNUTS AND INSULATED THROAT CONNECTORS WHERE CONDUIT ENTRIES PANELBOARD ENCLOSURES, WIREWAYS, STARTERS AND SWITCH ENCLOSURES, JUNCTION BOXES AND ALL METALLIC ENCLOSURE BOXES. FIELD-INSTALLABLE INSERTS WILL NOT BE ALLOWED.
9. MAKE FINAL CONNECTIONS TO MOTORS, VIBRATING EQUIPMENT AND WATER HEATERS WITH LIQUID-TIGHT FLEXIBLE METAL CONDUIT (LFMC) AND CONNECTORS. MAKE FINAL CONNECTIONS TO LIGHT FIXTURES WITH FLEXIBLE METAL CONDUIT (FMC) AND CONNECTORS.

10. PROVIDE INTUMESCENT FIRESEAL AT ALL SLEEVE AND CONDUIT PENETRATIONS THROUGH FIRE RATED WALLS TO MAINTAIN RATING OF WALLS.

11. PROVIDE GREEN COLORED INSULATED GROUNDING CONDUCTOR(S) IN ALL CONDUIT AND RACEWAY SYSTEMS.

12. FUSES SHALL BE DUAL-ELEMENT, NEMA CLASS RK1 OR RK5.

13. SUPPORT ALL LIGHTING FIXTURES INDEPENDENTLY OF ALL SUSPENDED CEILINGS. SUPPORT THE FIXTURES FROM THE STRUCTURE ABOVE WITH 2#10 TIE WIRES.

14. VERIFY ALL DOOR SWINGS WITH THE FINAL ARCHITECTURAL DRAWINGS PRIOR TO ROUGHING-IN ANY SWITCH OUTLET BOXES.

15. OUTLETS WHICH ARE NOTED FOR A PARTICULAR PIECE OF EQUIPMENT ARE SO NOTED IN ORDER THAT COORDINATION OF THE LOCATION OF THE OUTLET WITH THE CONNECTING LOCATION OF THE EQUIPMENT CAN OCCUR. THIS COORDINATION SHALL BE INCLUDED AS PART OF THE WORK OF DIVISION 26.

16. OUTLET AND JUNCTION BOXES SHALL NOT BE MOUNTED BACK-TO-BACK IN WALLS. ASSURE MINIMUM 24" HORIZONTAL SEPARATION IN RATED FIRE WALLS.

17. CIRCUIT DIRECTORIES FOR PANELBOARDS SHALL BE TYPE-WRITTEN; HAND-WRITTEN DIRECTORIES WILL NOT BE ALLOWED.

18. REVIEW CONTROL SCHEMATICS AND DIAGRAMS ON MECHANICAL DRAWINGS DIVISION 23 IN ORDER TO INCLUDE ACCESSORIES REQUIRED WITH MOTOR CONTROLLER DEVICES PROVIDED UNDER DIVISION 26.
19. PROVIDE A TEMPORARY PRIMARY SERVICE FROM A POWER COMPANY SOURCE TO THE FACILITY SITE FOR LIGHT AND POWER REQUIREMENTS DURING CONSTRUCTION. MEET OR EXCEED OSHA STANDARDS FOR ELECTRICAL DISTRIBUTION AND SAFETY ON CONSTRUCTION SITES.

20. SERVICE ENTRANCE EQUIPMENT SHALL BE MARKED IN ACCORDANCE WITH NEC 110.24, INDICATING MAXIMUM AVAILABLE FAULT CURENT. MARKING SHALL BE IN ACCORDANCE WITH STUDY PERFORMED PER DIVISION 26 SPECIFICATIONS AND SHALL INCLUDE DATE OF STUDY.

21. ALL SECURITY EQUIPMENT REQUIRED (SACS CARD READERS, CCTV EQUIPMENT, RACKS AND ALL ACCESSORIES) SHALL BE FURNISHED BY THE CONTRACTOR UNDER THE SCOPE OF THIS PROJECT FROM THE AIRPORT'S ACTIVELY CONTRACTED SECURITY VENDOR, MC DEAN (404-606-6778) TO MATCH THE EXISTING INSTALLATION AT HJAA. ALL EQUIPMENT SHALL BE FURNISHED, COORDINATED AND INSTALLED UNDER THE SUPERVISION OF THIS VENDOR.

22. ALL COMMUNICATIONS/DATA EQUIPMENT REQUIRED FOR A COMPLETE AND WORKING SYSTEM SHALL BE FURNISHED BY THE CONTRACTOR UNDER THE SCOPE OF THIS PROJECT AS DIRECTED BY HJAAI DIT DEPARTMENT, TO MATCH THE EXISTING INSTALLATION AT HJAA. INSTALLATION OF ALL EQUIPMENT SHALL BE COORDINATED AND PERFORMED UNDER THE SUPERVISION OF HJAAI DIT.

LEGEND:

- (MOUNTING HEIGHTS GIVEN ARE TO CENTERLINE OF DEVICE UNLESS NOTED OTHERWISE)
- HA-1,3,5
- HA-1,3,5 (EXAMPLE ONLY) INDICATES HOMERUN OF CIRCUITS 1, 3 AND 5 TO PANELBOARD HA. THE NUMBERS 3 OR 5 ADJACENT TO AN ARROW INDICATES A CIRCUIT CONTINUATION. MINIMUM CIRCUIT REQUIREMENTS ARE TWO NO. 12 CONDUCTORS AND ONE NO. 12 EQUIPMENT GROUNDING CONDUCTOR. NUMBER(S) AND LOWER CASE LETTER(S) INDICATE CIRCUIT AND SWITCH-LEG DESIGNATIONS RESPECTIVELY. CAPITAL LETTER INDICATES LIGHT FIXTURE TYPE.
- RECESSED OR SURFACE MOUNTED FLUORESCENT FIXTURE, SHADING INDICATES EMERGENCY FIXTURE
- FLUORESCENT STRIP FIXTURE, SHADING INDICATES EMERGENCY FIXTURE
- WALL MOUNTED FLUORESCENT FIXTURE, SHADING INDICATES EMERGENCY FIXTURE
- RECESSED OR SURFACE MOUNTED DOWNLIGHT, SHADING INDICATES EMERGENCY FIXTURE
- WALL MOUNTED FIXTURE, SHADING INDICATES EMERGENCY FIXTURE
- CEILING OR WALL MOUNTED EXIT LIGHT WITH DIRECTIONAL ARROWS AS SHOWN, DARKENED QUADRANT INDICATES FACE
- EXTERIOR APRON FLOODLIGHT, POLE MOUNTED TO TENON MAST WITH QUANTITY OF FIXTURES AS INDICATED
- EXTERIOR POLE MOUNTED FIXTURE; POLE AND CONCRETE BASE WITH QUANTITY OF FIXTURES AS INDICATED
- CEILING OR WALL MOUNTED JUNCTION BOX
- EMERGENCY BATTERY PACK WITH 2 LAMP HEADS
- JUNCTION BOX MOUNTED FLUSH IN FLOOR
- DUPLEX RECEPTACLE, NEMA 5-20R, MOUNT 18" AFF UNO. STANDARD RECEPTACLE UNLESS NOTED AS FOLLOWS:
- "GF" = GROUND FAULT CIRCUIT INTERRUPTER  
"WP" = WEATHERPROOF COVER
- DOUBLE DUPLEX RECEPTACLE, NEMA 5-20R, MOUNT 18" AFF UNO. STANDARD RECEPTACLE UNLESS NOTED AS FOLLOWS:
- "GF" = GROUND FAULT CIRCUIT INTERRUPTER  
"WP" = WEATHERPROOF COVER
- SPECIAL PURPOSE RECEPTACLE, NEMA CONFIGURATION AS INDICATED, MOUNT 18" AFF UNO
- DUPLEX RECEPTACLE, NEMA 5-20R, MOUNTED FLUSH IN FLOOR
- DUPLEX RECEPTACLE, NEMA 5-20R, MOUNTED FLUSH IN CEILING.
- SURFACE MOUNTED MULTI-OUTLET RACEWAY ASSEMBLY, RECEPTACLES SPACED 12" ON CENTER OR AS INDICATED, MOUNT TO MILLWORK AS INDICATED.
- COMBINATION DATA/TELEPHONE OUTLET WITH PORTS AS NOTED. MOUNT 18" AFF UNO  
D = DATA  
V = VOICE
- CABLE TELEVISION OUTLET BOX, MOUNT 84" AFF UNO
- SINGLE-POLE TOGGLE SWITCH, MOUNT 48" AFF
- THREE-WAY TOGGLE SWITCH, MOUNT 48" AFF
- FOUR-WAY TOGGLE SWITCH, MOUNT 48" AFF
- DIMMER SWITCH, MOUNT 48" AFF
- WALL BOX OCCUPANCY SENSOR, MOUNT 48" AFF
- CEILING MOUNTED OCCUPANCY SENSOR
- POWER PACK FOR CEILING MOUNTED OCCUPANCY SENSOR

- FIRE ALARM MANUAL PULL STATION, MOUNT 48" AFF
- FIRE ALARM COMBINATION AUDIO/VISUAL SIGNAL DEVICE, 75 CANDELA UNLESS NOTED, BOTTOM MOUNTED 80" AFF
- FIRE ALARM VISUAL ONLY SIGNAL DEVICE, CANDELA VALUE INDICATED, BOTTOM MOUNTED 80" AFF
- CEILING OR WALL MOUNTED SMOKE DETECTOR
- CEILING MOUNTED THERMAL DETECTOR
- FIRE ALARM FLOW SWITCH
- FIRE ALARM TAMPER SWITCH
- FIRE ALARM PRESSURE SWITCH
- PANELBOARD, FLUSH MOUNTED
- PANELBOARD, SURFACE MOUNTED
- EQUIPMENT PLYWOOD BACKBOARD, SIZE AS INDICATED
- DRY-TYPE TRANSFORMER, KVA AS INDICATED OR SCHEDULED
- MOTOR, HP AS INDICATED; M INDICATES FRACTIONAL HORSEPOWER.
- PACKAGE CONTROL PANEL WITH MOTOR STARTER/CONTROLLER/CIRCUIT BREAKER OR DISCONNECT PROVIDED BY DIVISION 23
- EQUIPMENT OR PANEL AS INDICATED
- MOTOR RATED SWITCH WITH THERMAL OVERLOAD PROTECTION (MANUAL MOTOR STARTER)
- COMBINATION STARTER/DISCONNECT SWITCH; AMPS/POLES/FUSES AS INDICATED
- HEAVY DUTY NOT-FUSIBLE DISCONNECT SWITCH; AMPS/POLES AS INDICATED.
- HEAVY DUTY FUSIBLE DISCONNECT SWITCH; AMPS/POLES/FUSES AS INDICATED.
- CONDUIT INSTALLED CONCEALED IN WALLS AND/OR ABOVE CEILING
- CONDUIT INSTALLED CONCEALED IN/OR BELOW FLOOR SLAB OR BELOW GRADE
- CONDUIT INSTALLED EXPOSED
- CONDUIT TURNING UP/CONDUIT TURNING DOWN
- CONDUIT TERMINATION, STUB-OUT WITH THREADED OR SETSCREW CAP
- CONNECTION TO GROUNDING ELECTRODE
- LIGHTNING PROTECTION AIR TERMINAL
- COPPER GROUND BUSBAR WITH 5/16" HOLES, MOUNT 18" AFF
- SMOKE DAMPER
- SACS CARD READER, 48" AFF
- CCTV CAMERA, WALL MOUNT 10'-0" AFG UNO
- DOOR PUSH TO EXIT PUSHBUTTON, 48" AFF

ABBREVIATIONS:

A	AMPERES		
AC	ABOVE CEILING	N	NEUTRAL, NEUTRAL CONDUCTOR OR GROUNDED CONDUCTOR
AFF	ABOVE FINISHED FLOOR		
AFG	ABOVE FINISHED GRADE	NC	NORMALLY CLOSED
AIC	AMPERE INTERRUPTING CAPACITY	NEC	NATIONAL ELECTRICAL CODE
AM	AMMETER	NF	NOT FUSIBLE
ATS	AUTOMATIC TRANSFER SWITCH	NIC	NOT IN CONTRACT
AWG	AMERICAN WIRE GAUGE	NL	NIGHT LIGHT, NOT SWITCHED
BC	BELOW CEILING	NMC	NON-METALLIC CONDUIT
C or C.	CONDUIT	NO	NORMALLY OPEN
CB	CIRCUIT BREAKER	NTS	NOT TO SCALE
CLG	CEILING	OCF	OVERCURRENT PROTECTION
DISP	DISPOSAL	P	POLE
DS	DISCONNECT SWITCH	PB	PULLBOX
DW	DISHWASHER	PH	PHASE
EC	EMPTY CONDUIT	PNLBD	PANELBOARD
EGC	EQUIPMENT GROUNDING CONDUCTOR	PVC	POLYVINYL CHLORIDE
EMT	ELECTRICAL METALLIC TUBING	RCPT	RECEPTACLE
ER	EXISTING REMOVED	REF	REFRIGERATOR
ERR	EXISTING REMOVED/RELOCATED	RGSC	RIGID GALVANIZED STEEL CONDUIT
EW	ELECTRIC WATER COOLER	SPD	SURGE PROTECTION DEVICE
EX	EXISTING TO REMAIN	SPEC	SPECIFICATION
FACP	FIRE ALARM CONTROL PANEL	ST	SHUNT TRIP
FD	FIRE DAMPER	SW	SWITCH
FMC	FLEXIBLE METALLIC CONDUIT	SWBD	SWITCHBOARD
FWE	FURNISHED WITH EQUIPMENT		
G	GROUND OR EQUIPMENT GROUNDING CONDUCTOR	TYP	TYPICAL
GEC	GROUNDING ELECTRODE CONDUCTOR	UC	UNDER COUNTER
GFCI	GROUND FAULT CIRCUIT INTERRUPTER	UG	UNDERGROUND
HOA	HAND-OFF-AUTOMATIC	UL	UNDERWRITER'S LABORATORIES
HP	HORSEPOWER	UNO	UNLESS NOTED OTHERWISE
IG	ISOLATED GROUND OR ISOLATED GROUNDING CONDUCTOR	V	VOLTS
J-BOX	JUNCTION BOX	VA	VOLT AMPERES
KV	KILOVOLT	VFD	VARIABLE FREQUENCY DRIVE
kVA	KILOVOLT AMPERES	VM	VOLT METER
LFMC	LIQUIDTIGHT FLEXIBLE METALLIC CONDUIT	W	WATT
MAX.	MAXIMUM	WM	WATT METER
MCB	MAIN CIRCUIT BREAKER	WP	WEATHERPROOF
MCC	MOTOR CONTROL CENTER	XFMR	TRANSFORMER
MH	MANHOLE		
MIN.	MINIMUM		
MLO	MAIN LUG ONLY		
MTD	MOUNTED		
MW	MICROWAVE OVEN		



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NO. DATE BY REVISION

AIR CARGO BUILDING C

ELECTRICAL LEGEND,  
GENERAL NOTES &  
LIGHTING FIXTURE SCHEDULE

WBS NUMBER:  
D.07.55.009

FC NUMBER:  
FC-6006007929-A

A/E PROJECT NUMBER:  
HII-0730621

DRAWN BY:  
M. TRINKER

DESIGNED BY:  
M. TRINKER

CHECKED BY:  
S. SVEDA

APPROVED BY:  
S. SVEDA

DATE:  
11/25/2014


SCALE:  
NONE

SHEET NO.:

E01.1

NOT RELEASED FOR CONSTRUCTION



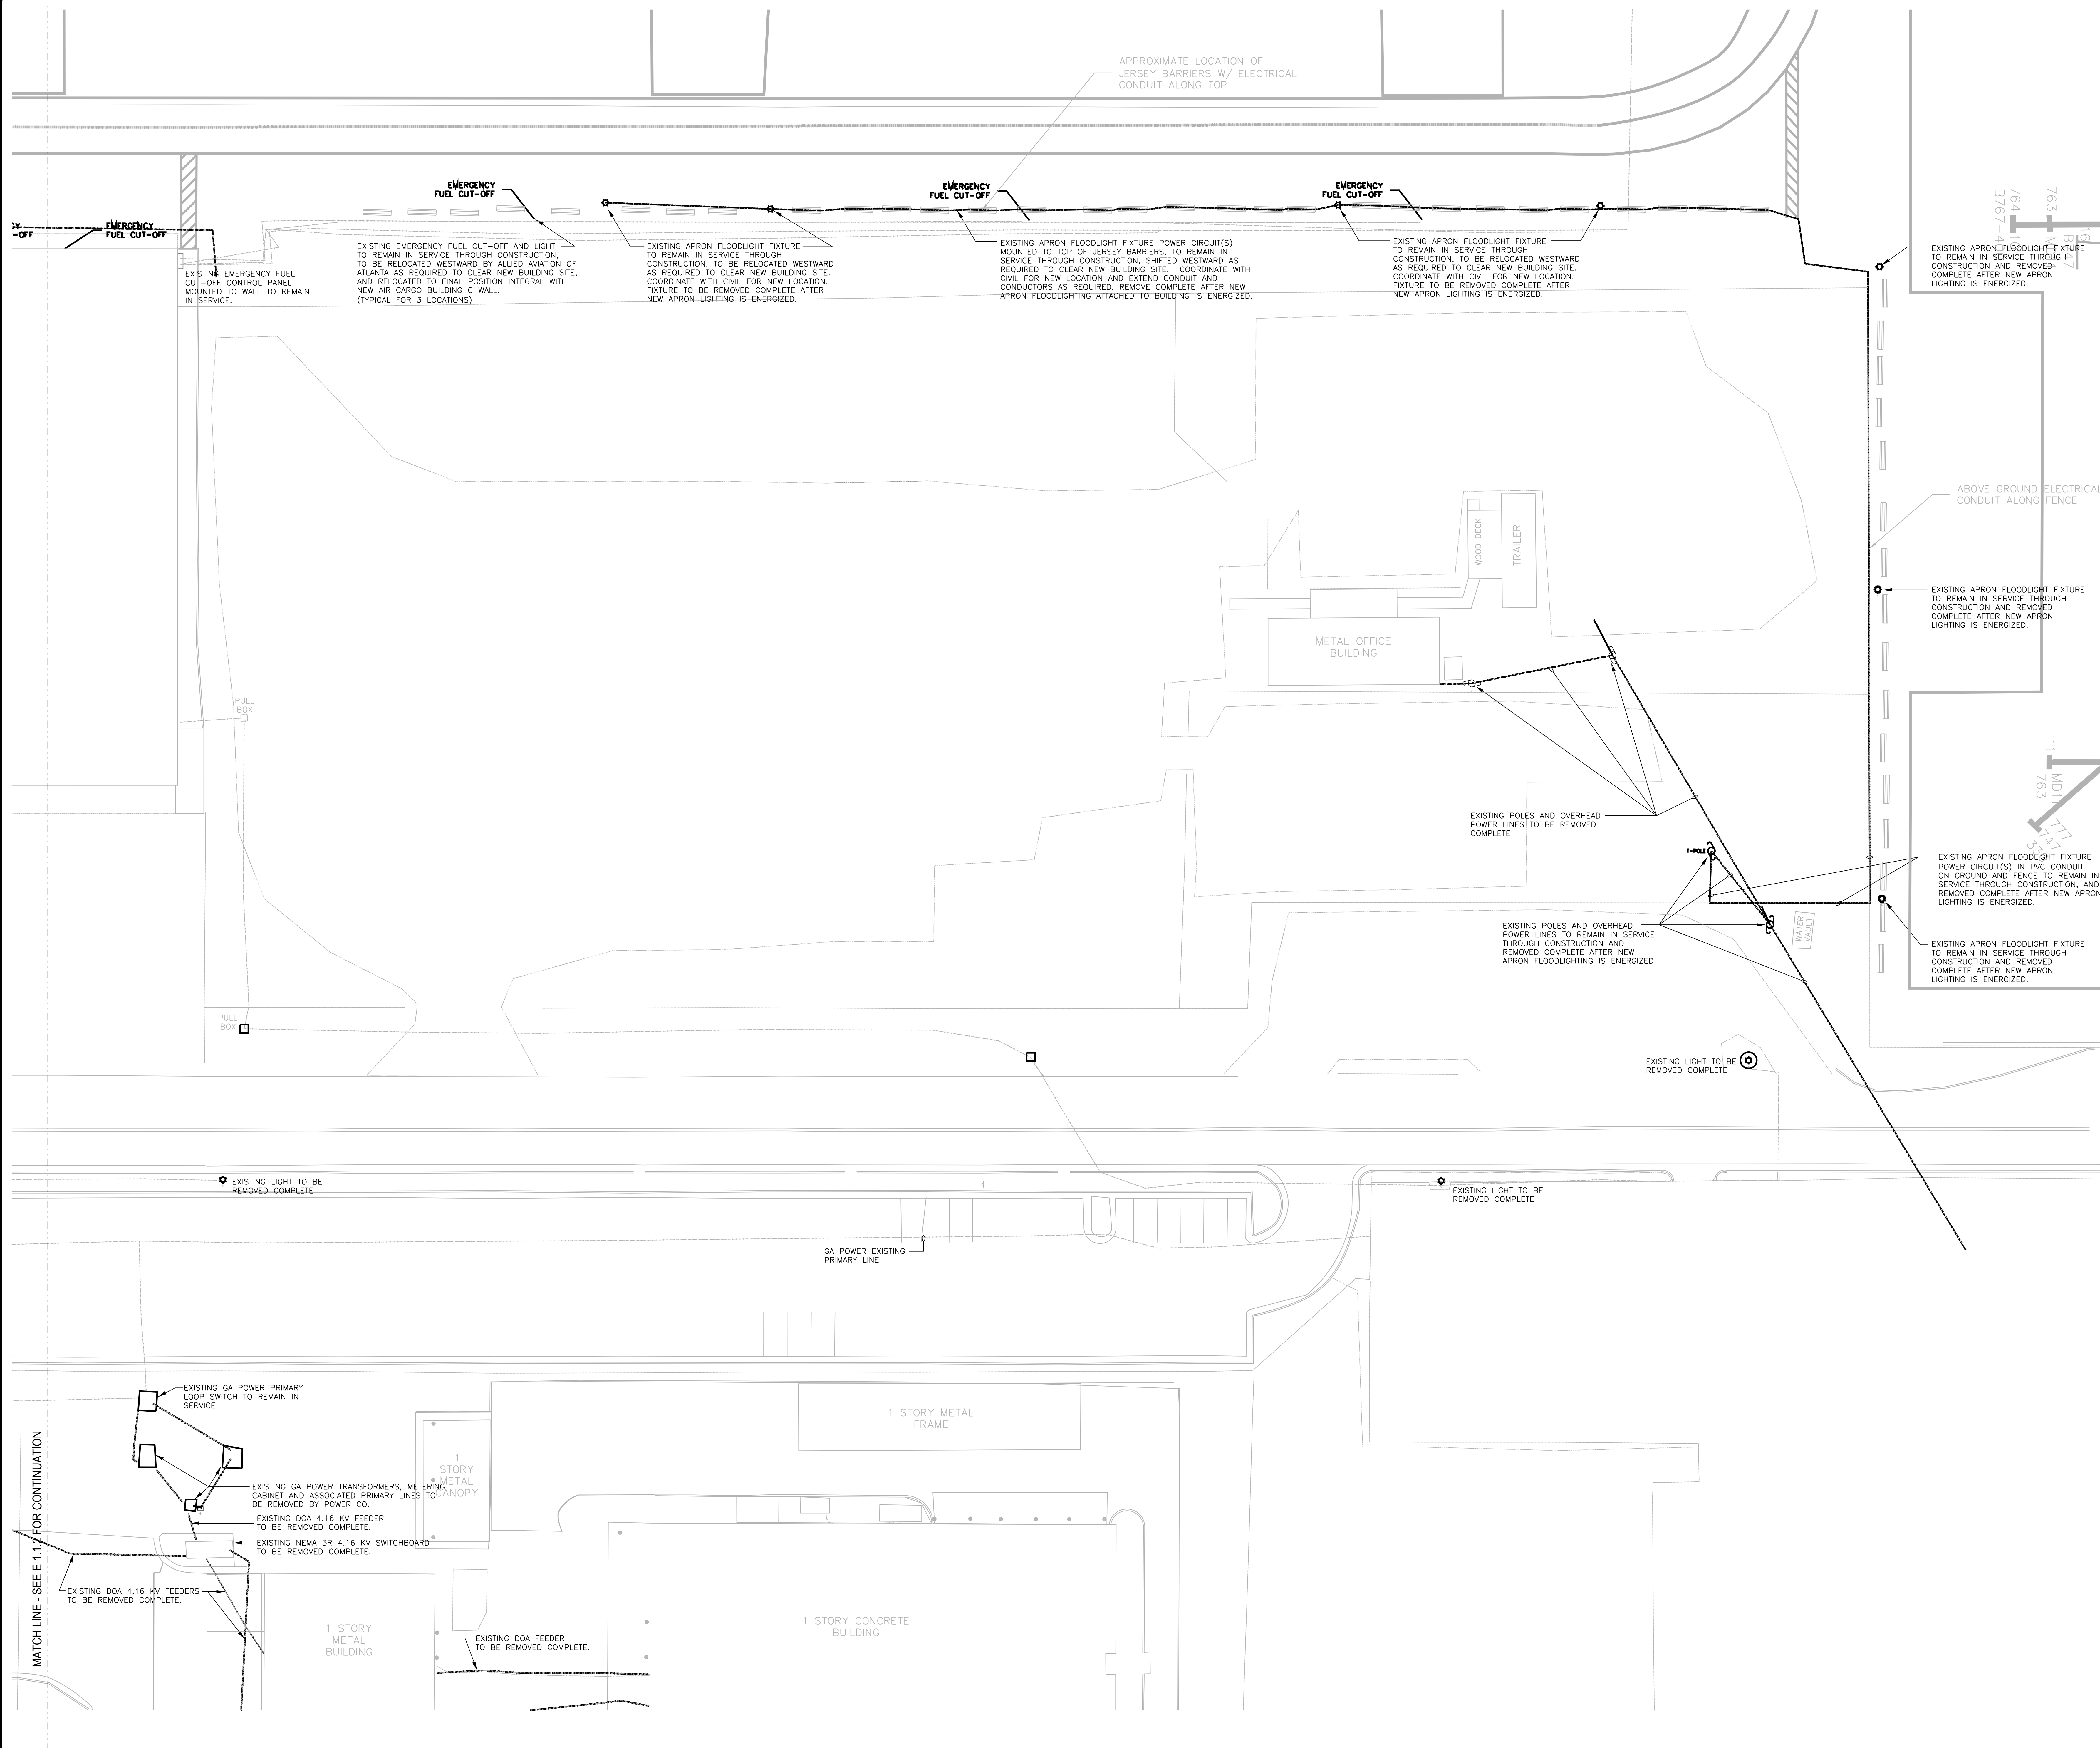

1  
E 1.1.1  
ELECTRICAL SITE PLAN - DEMOLITION  
SCALE: 1"=20'-0"



CITY OF ATLANTA, GEORGIA

Hartsfield-Jackson  
Atlanta International Airport



HEERY INTERNATIONAL, INC. 999  
PEACHTREE STREET, NE  
ATLANTA, GA 30309  
PHONE: 404.419.9190  
FAX: 404.946.2017

MATRIX 3D  
44 BROAD STREET  
ATLANTA, GA 30303  
PHONE: 404.522.3801  
FAX: 404.522.3803

STEVENS & HARRISON, INC.  
100 PEACHTREE STREET NW, SUITE 2000  
ATLANTA, GA 30333  
PHONE: 404.522.6888  
FAX: 404.522.6204

SOUTHEASTERN ENGINEERING, INC. (SEI)  
201 SANDY PLAINS ROAD  
MARIETTA, GA 30066  
PHONE: 770.321.9308  
FAX: 770.321.3935

NO. DATE BY REVISION

AIR CARGO BUILDING C

ELECTRICAL  
SITE PLAN  
DEMOLITION

WBS NUMBER:  
D.07.55.009

DRAWN BY:  
M. TRINKER

FC NUMBER:  
FC-6006007529-A

DESIGNED BY:  
M. TRINKER

A/E PROJECT NUMBER:  
HII-0730621

CHECKED BY:  
S. SVEDA

APPROVED BY:  
S. SVEDA


DATE:  
11/25/2014

SCALE:  
1"=20'-0"

SHEET NO.:

E 1.1.1

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AIR CARGO BUILDING C, 100% CONSTRUCTION DOCUMENTS ISSUED FOR BID, NOVEMBER 25, 2014
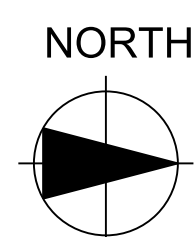
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HEERY INTERNATIONAL, INC. 599  
PEACHTREE STREET, NE  
ATLANTA, GA 30309  
PHONE: 404.419.9190  
FAX: 404.946.2017


MATRIX 3D  
44 BROAD STREET  
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PHONE: 404.522.3800  
FAX: 404.522.3823

STEVENS & WILKINSON, INC.  
100 PEACHTREE STREET NW, SUITE 2500  
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FAX: 404.521.6204

SOUTHEASTERN ENGINEERING, INC. (S)  
2470 SANDY PLAINS ROAD  
MARIETTA, GA 30086  
PHONE: 770.321.3936  
FAX: 770.321.3935

FAIR CARGO BUILDING C. 100% CONSTRUCTION DOCUMENTS ISSUED FOR BID. NOVEMBER 25, 2014

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Atlanta International Airport

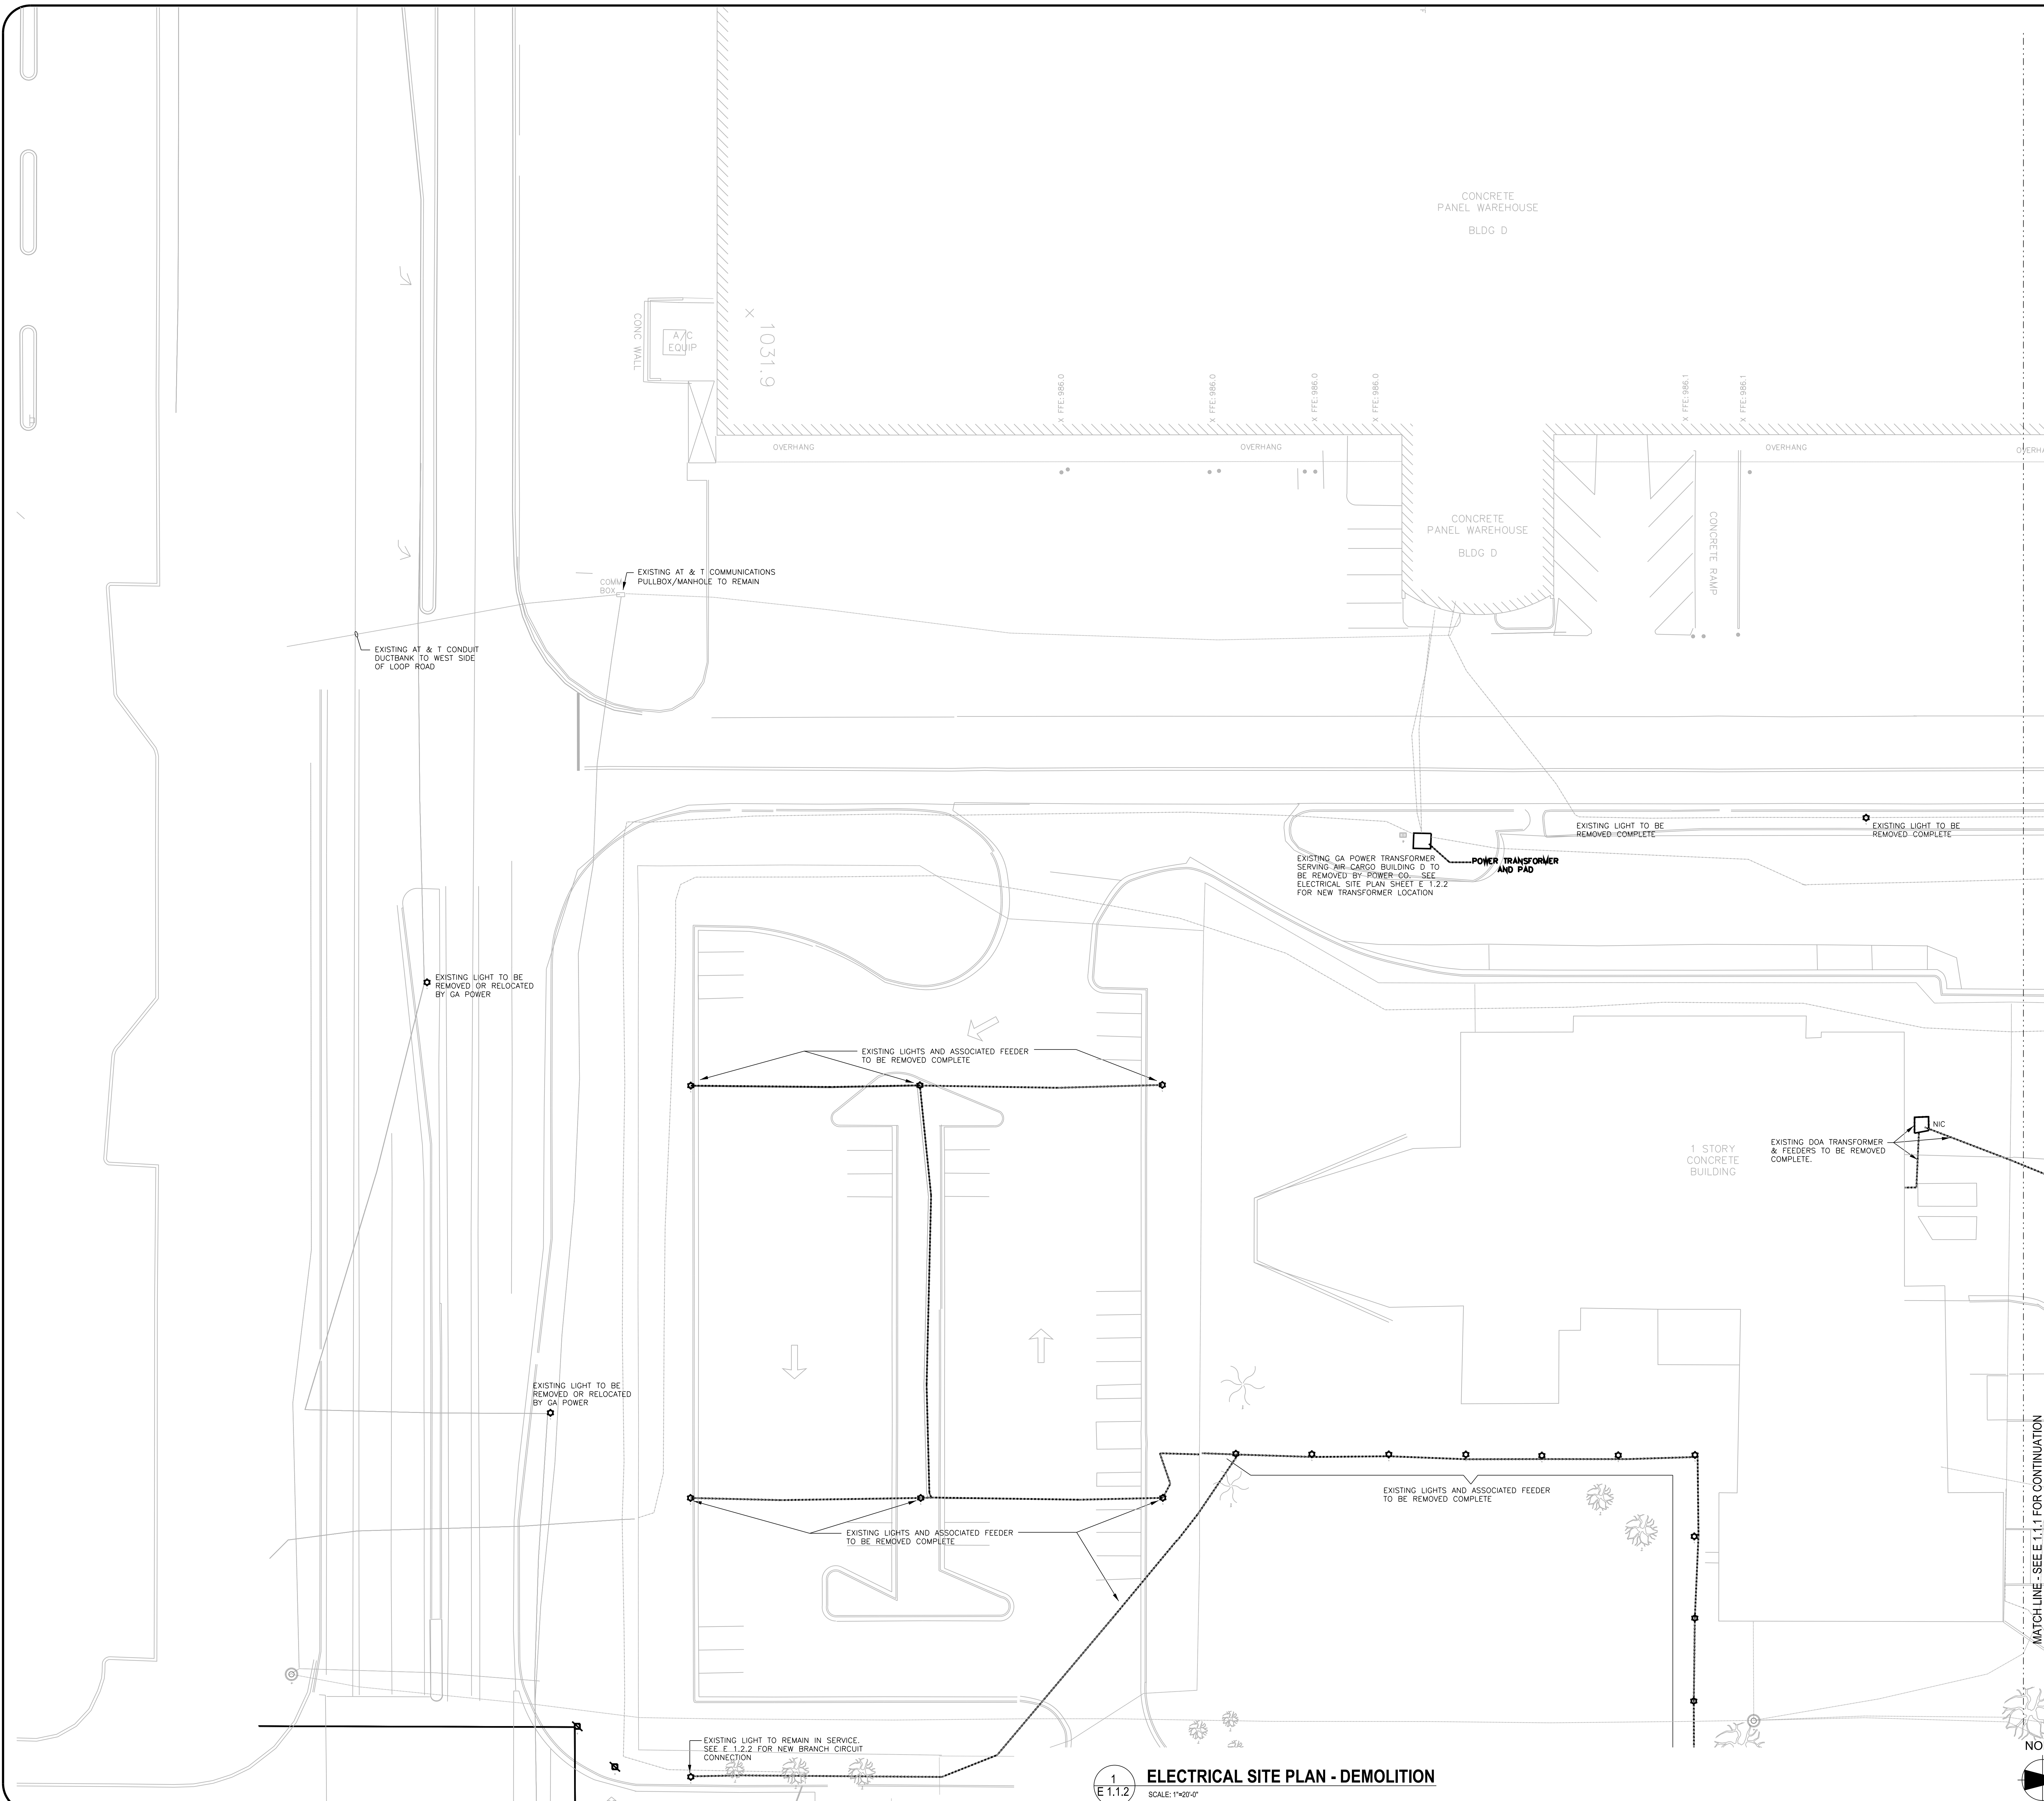


HEERY INTERNATIONAL, INC. 999  
PEACHTREE STREET, NE  
ATLANTA, GA 30309  
PHONE: 404.418.1190  
FAX: 404.582.2017

MATROX 3D  
44 BROAD STREET  
ATLANTA, GA 30303  
PHONE: 404.522.3801  
FAX: 404.522.3803

STEVENS & WEAVERSON, INC. (SEI)  
100 PEACHTREE STREET NW, SUITE 200  
ATLANTA, GA 30303  
PHONE: 404.522.6888  
FAX: 404.521.6204


SOUTHEASTERN ENGINEERING, INC. (SEI)  
201 SANDY PLAINS ROAD  
MARIETTA, GA 30066  
PHONE: 770.321.9308  
FAX: 770.321.3935

AIR CARGO BUILDING C, 100% CONSTRUCTION DOCUMENTS ISSUED FOR BID, NOVEMBER 25, 2014

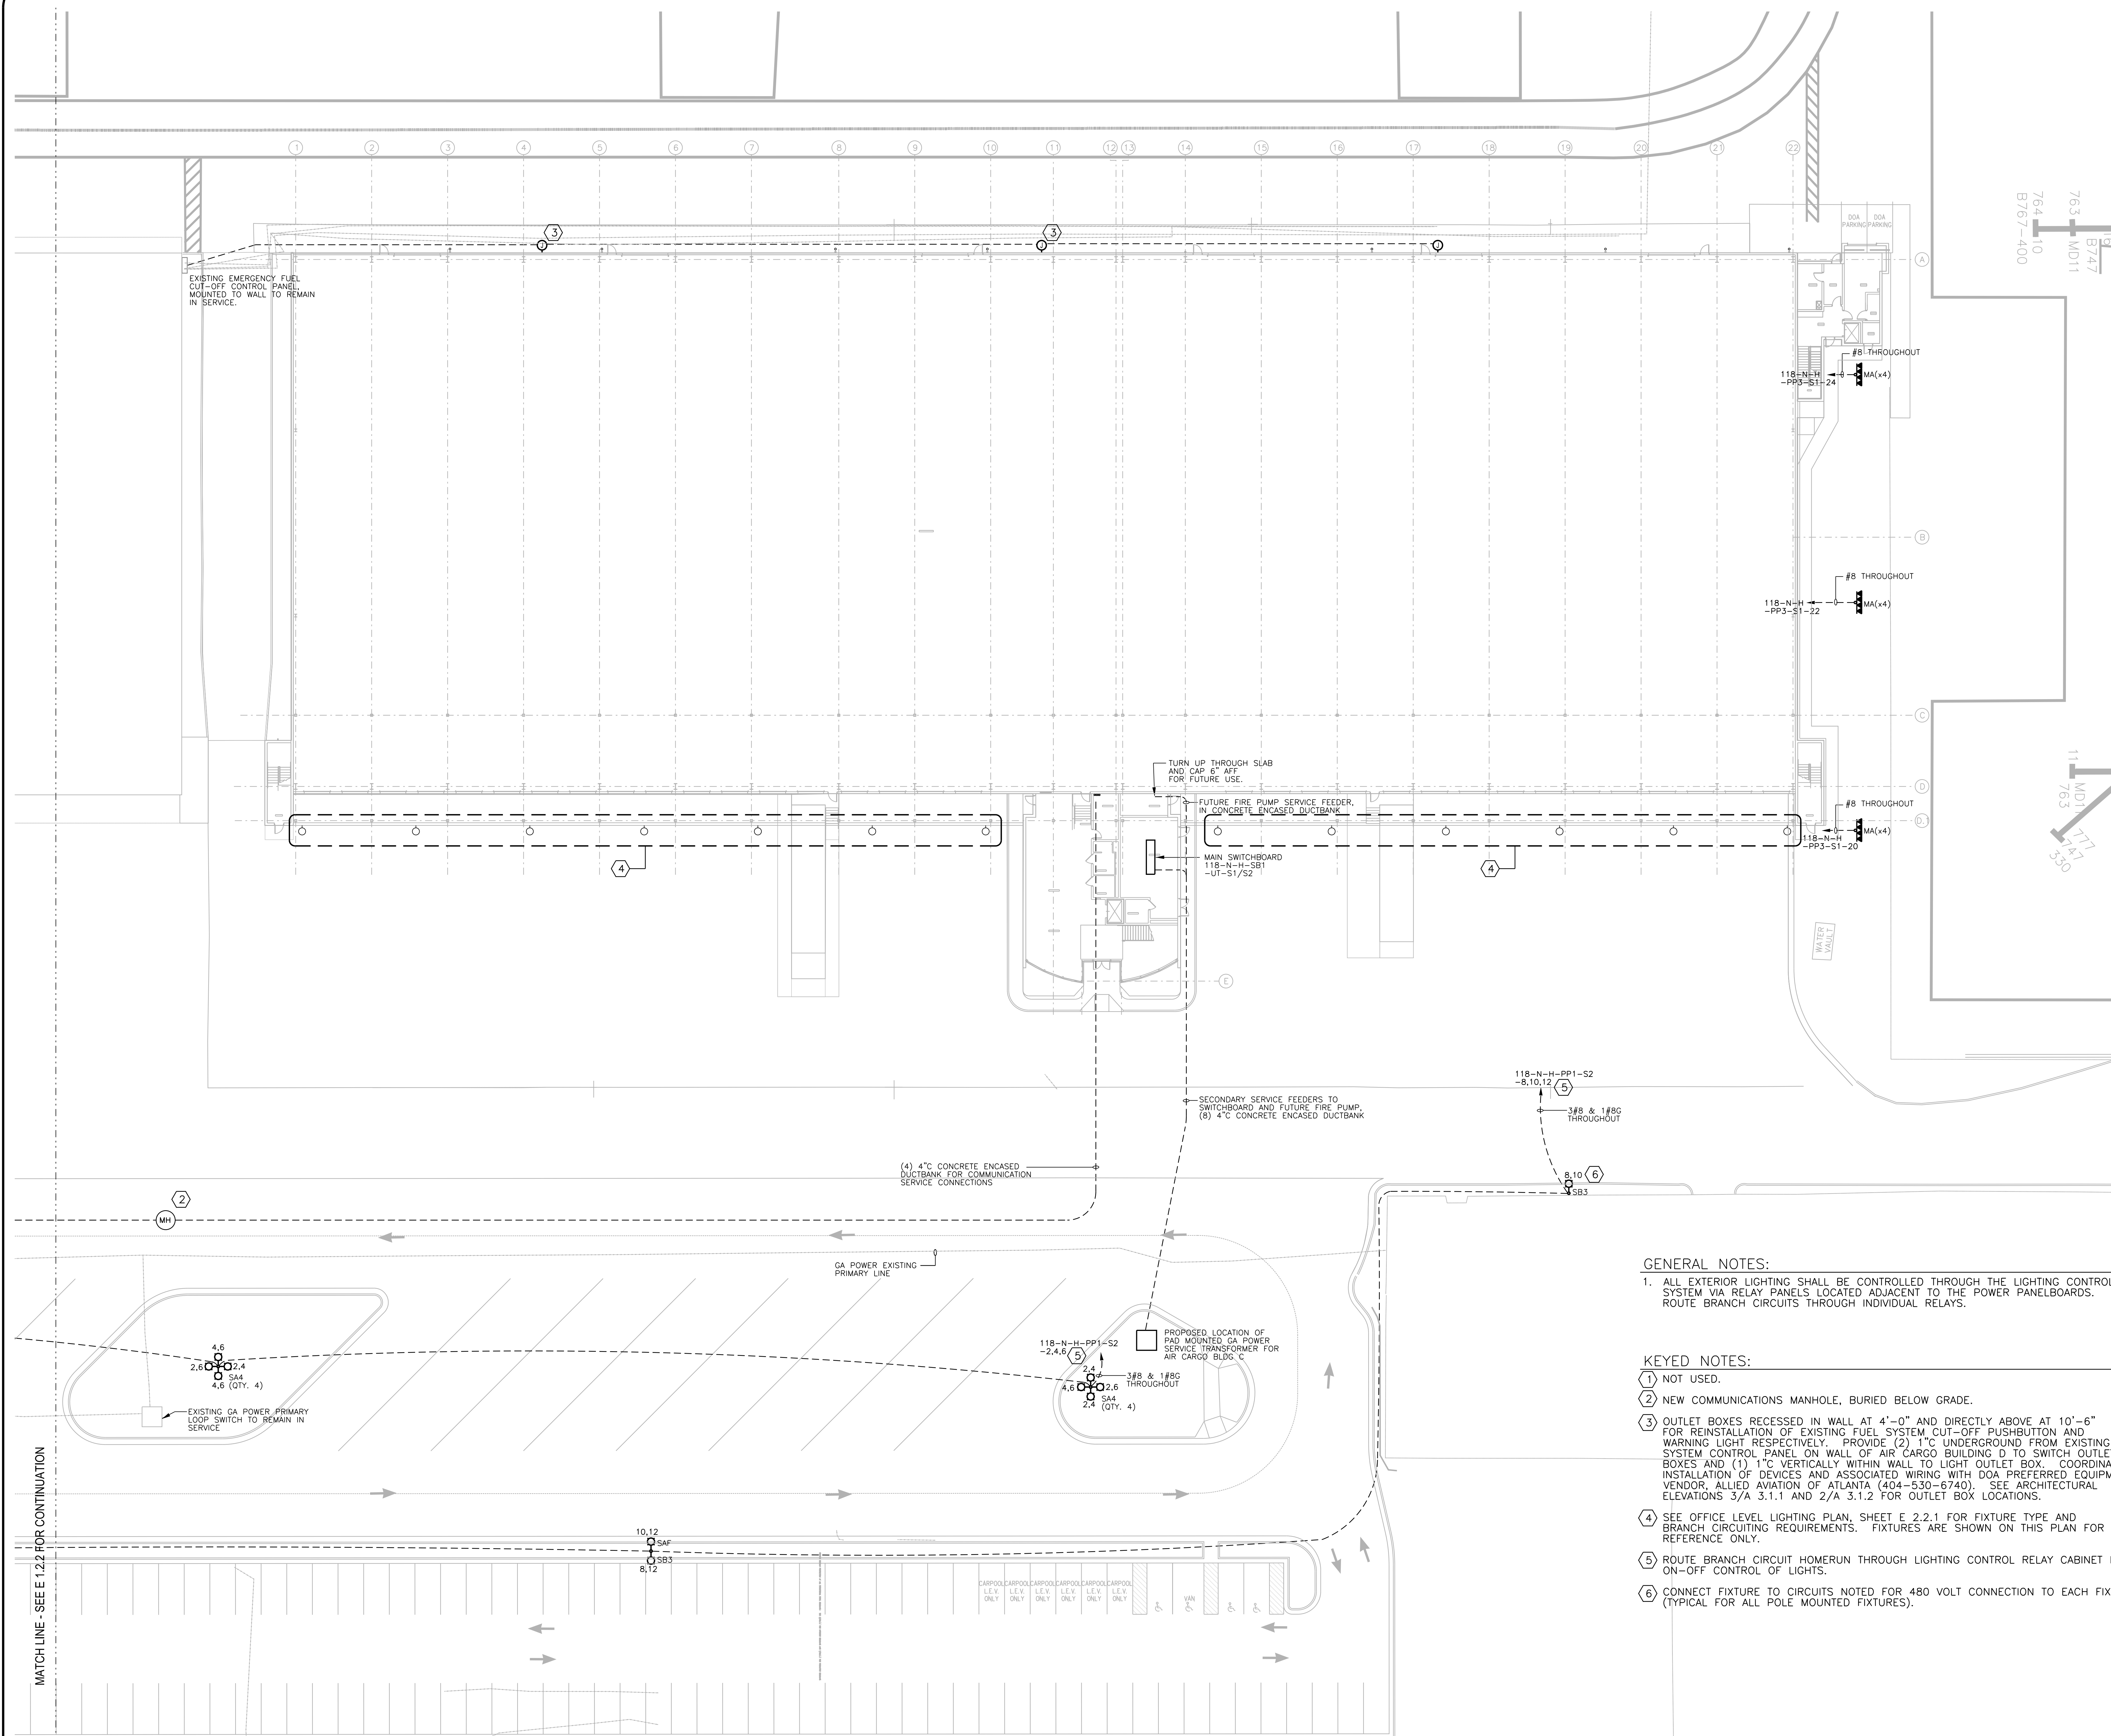

- GENERAL NOTES:**
1. ALL EXTERIOR LIGHTING SHALL BE CONTROLLED THROUGH THE LIGHTING CONTROL SYSTEM VIA RELAY PANELS LOCATED ADJACENT TO THE POWER PANELBOARDS. ROUTE BRANCH CIRCUITS THROUGH INDIVIDUAL RELAYS.
- KEYED NOTES:**
- 1 NOT USED.
  - 2 NEW COMMUNICATIONS MANHOLE, BURIED BELOW GRADE.
  - 3 OUTLET BOXES RECESSED IN WALL AT 4'-0" AND DIRECTLY ABOVE AT 10'-6" FOR REINSTALLATION OF EXISTING FUEL SYSTEM, CUT-OFF PUSHBUTTON AND WARNING LIGHT RESPECTIVELY. PROVIDE (2) 1" C UNDERGROUND FROM EXISTING SYSTEM CONTROL PANEL ON WALL OF AIR CARGO BUILDING D TO SWITCH OUTLET BOXES AND (1) 1" C VERTICALLY WITHIN WALL TO LIGHT OUTLET BOX. COORDINATE INSTALLATION OF DEVICES AND ASSOCIATED WIRING WITH DOA PREFERRED EQUIPMENT VENDOR, ALLIED AVIATION OF ATLANTA (404-530-6740). SEE ARCHITECTURAL ELEVATIONS 3/A 3.1.1 AND 2/A 3.1.2 FOR OUTLET BOX LOCATIONS.
  - 4 SEE OFFICE LEVEL LIGHTING PLAN, SHEET E 2.2.1 FOR FIXTURE TYPE AND BRANCH CIRCUITING REQUIREMENTS. FIXTURES ARE SHOWN ON THIS PLAN FOR REFERENCE ONLY.
  - 5 ROUTE BRANCH CIRCUIT HOMERUN THROUGH LIGHTING CONTROL RELAY CABINET FOR ON-OFF CONTROL OF LIGHTS.
  - 6 CONNECT FIXTURE TO CIRCUITS NOTED FOR 480 VOLT CONNECTION TO EACH FIXTURE (TYPICAL FOR ALL POLE MOUNTED FIXTURES).

**ELECTRICAL SITE PLAN**  
SCALE: 1"=20'-0"

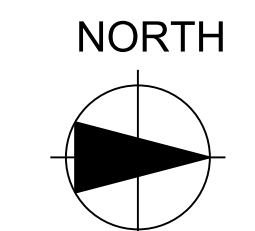

NO.				DATE	BY	REVISION
AIR CARGO BUILDING C						
ELECTRICAL SITE PLAN						
WBS NUMBER: D.07.55.009			DRAWN BY: M. TRINKER			
FC NUMBER: FC-6006007929-A			DESIGNED BY: M. TRINKER			
A/E PROJECT NUMBER: HII-0730621			CHECKED BY: S. SVEDA			
			APPROVED BY: S. SVEDA			
			DATE: 11/25/2014			
			SCALE: 1"=20'-0"			
			SHEET NO: E 1.2.1			

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CITY OF ATLANTA, GEORGIA

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PEACHTREE STREET, NE  
ATLANTA, GA 30309  
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PHONE: 404.522.0888  
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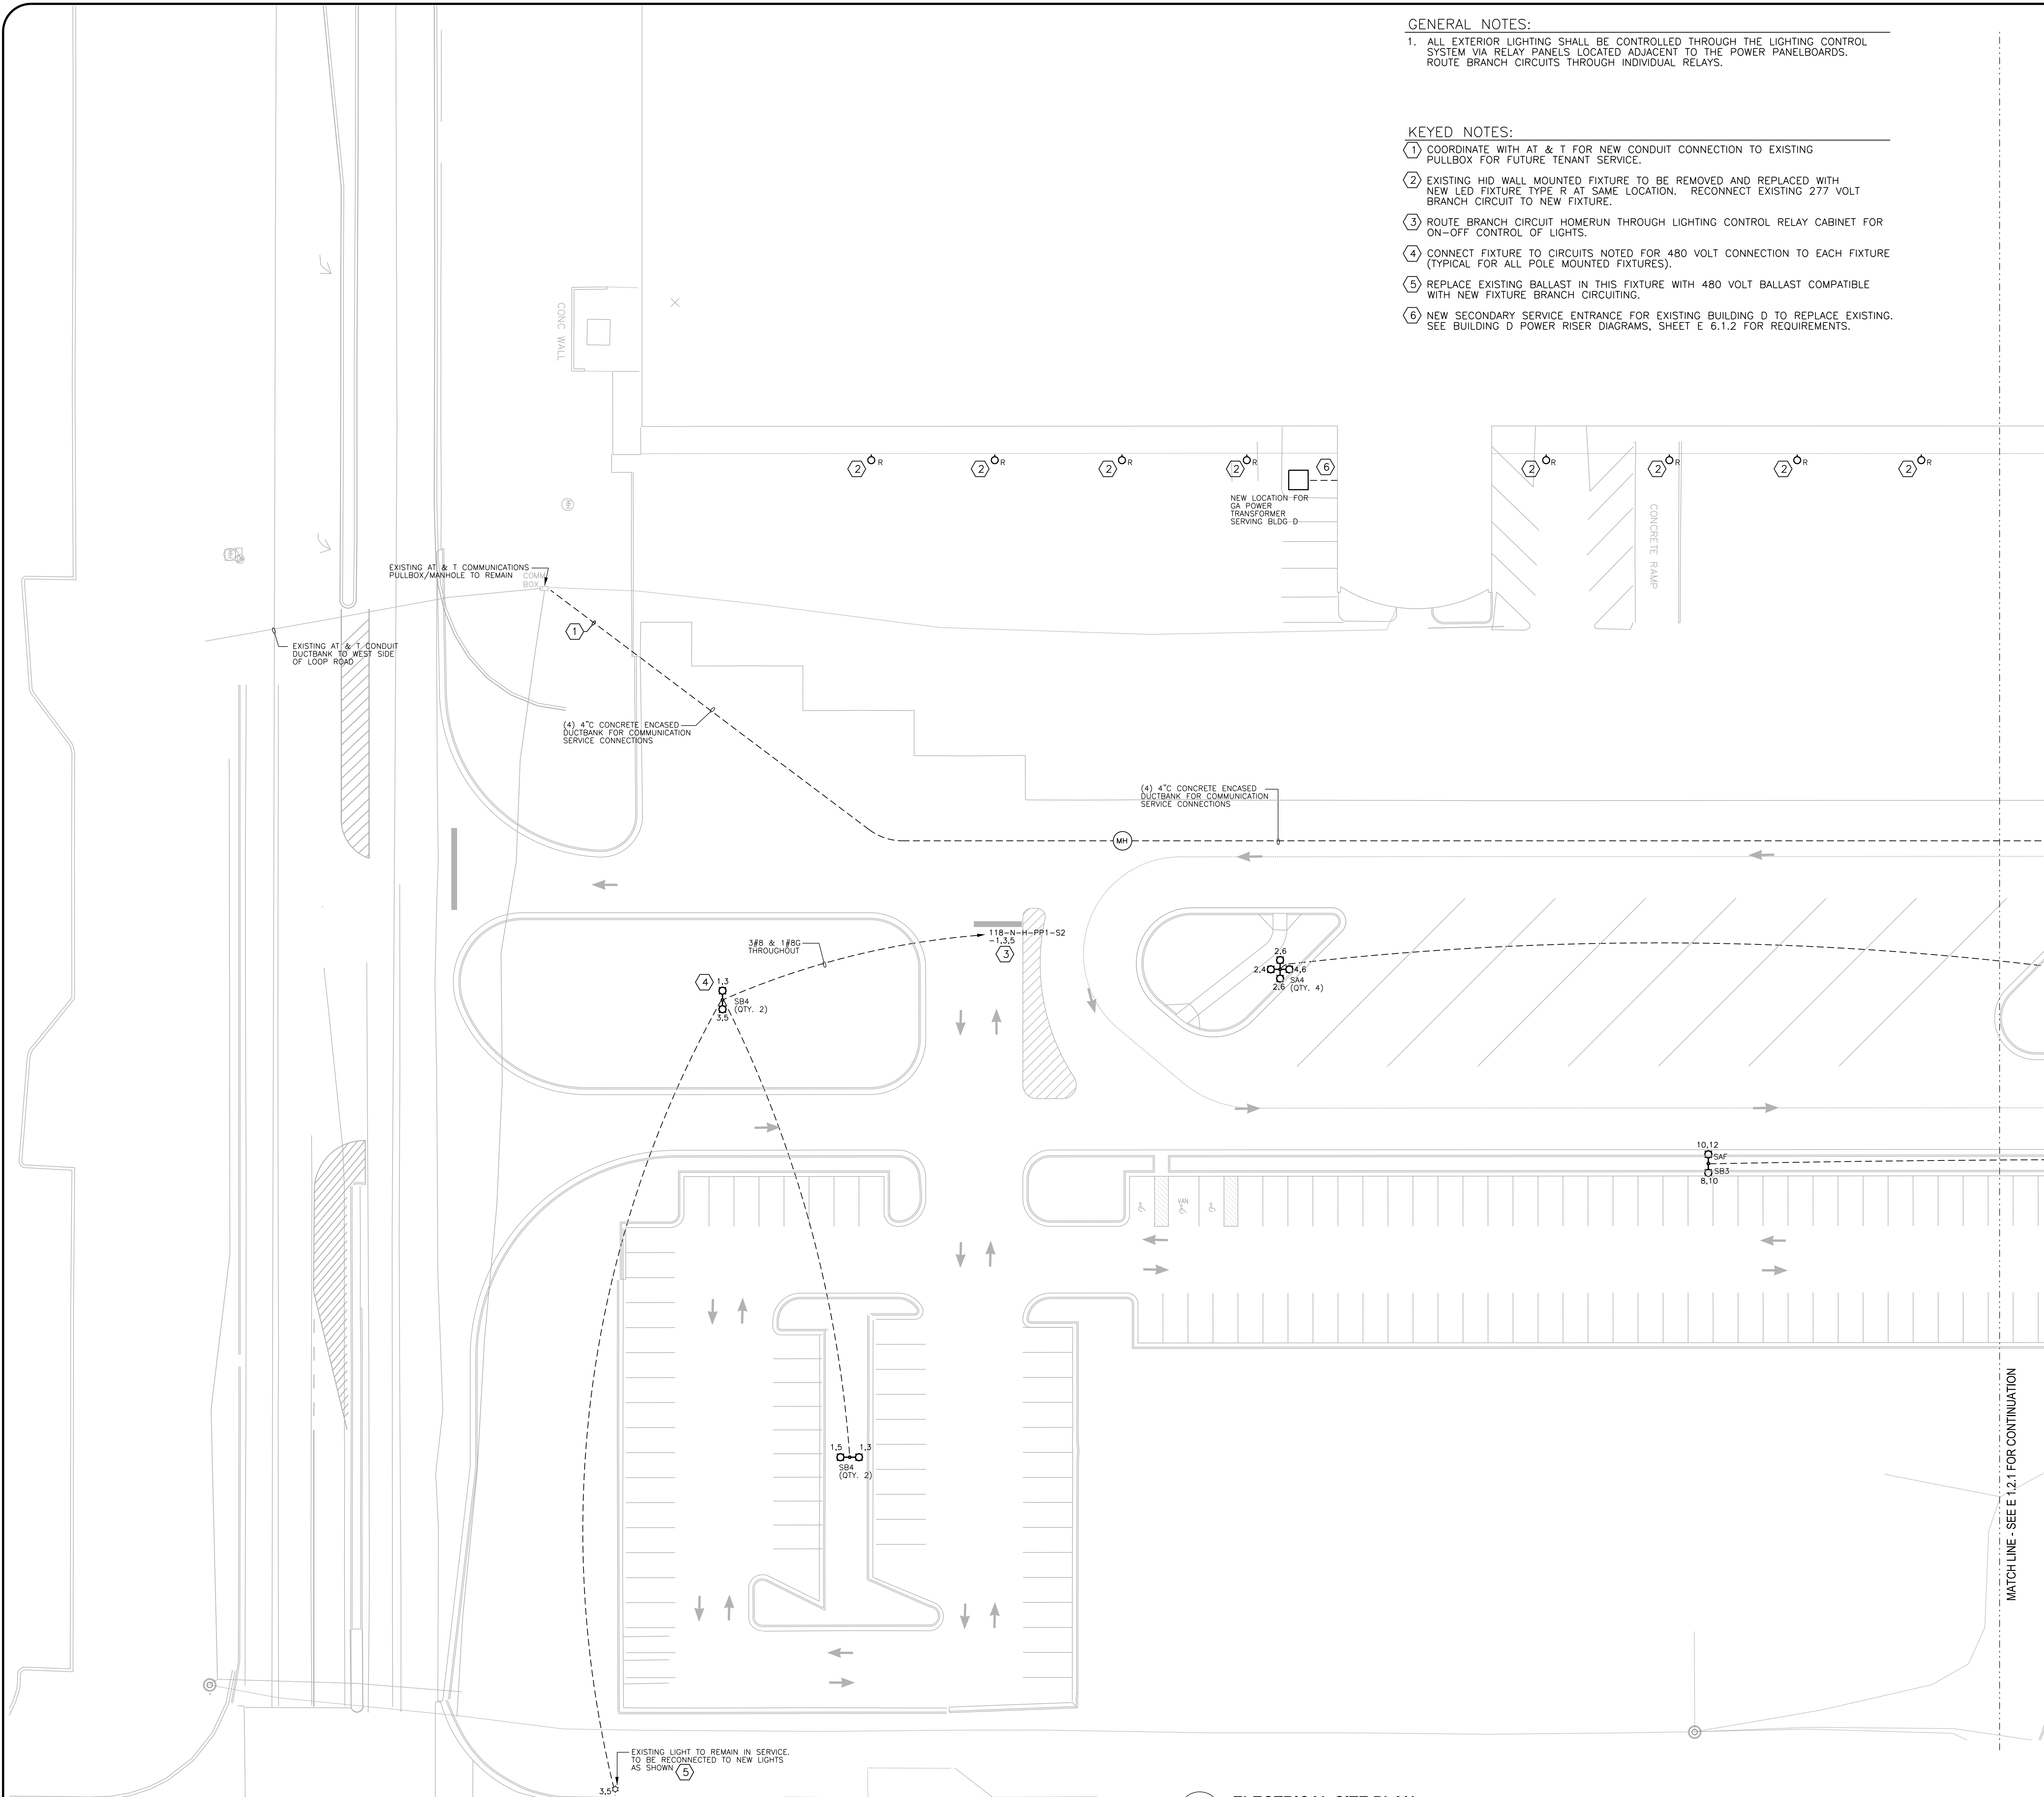
SOUTHEASTERN ENGINEERING, INC. (SEI)  
201 SANDY PLAINS ROAD  
MARIETTA, GA 30066  
PHONE: 770.321.9308  
FAX: 770.321.3935

#### GENERAL NOTES:

1. ALL EXTERIOR LIGHTING SHALL BE CONTROLLED THROUGH THE LIGHTING CONTROL SYSTEM VIA RELAY PANELS LOCATED ADJACENT TO THE POWER PANELBOARDS. ROUTE BRANCH CIRCUITS THROUGH INDIVIDUAL RELAYS.

#### KEYED NOTES:


1. COORDINATE WITH AT & T FOR NEW CONDUIT CONNECTION TO EXISTING PULLBOX FOR FUTURE TENANT SERVICE.
2. EXISTING HID WALL MOUNTED FIXTURE TO BE REMOVED AND REPLACED WITH NEW LED FIXTURE TYPE R AT SAME LOCATION. RECONNECT EXISTING 277 VOLT BRANCH CIRCUIT TO NEW FIXTURE.
3. ROUTE BRANCH CIRCUIT HOMERUN THROUGH LIGHTING CONTROL RELAY CABINET FOR ON-OFF CONTROL OF LIGHTS.
4. CONNECT FIXTURE TO CIRCUITS NOTED FOR 480 VOLT CONNECTION TO EACH FIXTURE (TYPICAL FOR ALL POLE MOUNTED FIXTURES).
5. REPLACE EXISTING BALLAST IN THIS FIXTURE WITH 480 VOLT BALLAST COMPATIBLE WITH NEW FIXTURE BRANCH CIRCUITING.
6. NEW SECONDARY SERVICE ENTRANCE FOR EXISTING BUILDING D TO REPLACE EXISTING. SEE BUILDING D POWER RISER DIAGRAMS, SHEET E 6.1.2 FOR REQUIREMENTS.



1  
E 1.2.2

#### ELECTRICAL SITE PLAN

SCALE: 1"=20'-0"

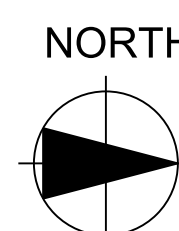

NO. DATE BY REVISION

AIR CARGO BUILDING C

#### ELECTRICAL SITE PLAN

WBS NUMBER:  
D.07.55.009

DRAWN BY:  
M. TRINKER

FC NUMBER:  
FC-6006007529-A

DESIGNED BY:  
M. TRINKER

A/E PROJECT NUMBER:  
HII-0730621

CHECKED BY:  
S. SVEDA

APPROVED BY:  
S. SVEDA

DATE:  
11/25/2014

SCALE:  
1"=20'-0"

SHEET NO.:

E 1.2.2

SEAL

AIR CARGO BUILDING C, 100% CONSTRUCTION DOCUMENTS ISSUED FOR BID, NOVEMBER 25, 2014

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Hartsfield-Jackson  
Atlanta International Airport




HEERY INTERNATIONAL, INC. 999  
PEACHTREE STREET, NE  
ATLANTA, GA 30309  
PHONE: 404.416.9190  
FAX: 404.582.2017

MATROX 3D  
44 BROAD STREET  
ATLANTA, GA 30303  
PHONE: 404.522.3801  
FAX: 404.522.3803

STEVENS & WEAVERSON, INC. (SEI)  
100 PEACHTREE STREET, SUITE 2000  
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PHONE: 770.321.9008  
FAX: 404.521.6204

SOUTHEASTERN ENGINEERING, INC. (SEI)  
201 SANDY PLAINS ROAD  
MARIETTA, GA 30066  
PHONE: 770.321.9008  
FAX: 770.321.3935

AIR CARGO BUILDING C, 100% CONSTRUCTION DOCUMENTS ISSUED FOR BID, NOVEMBER 25, 2014

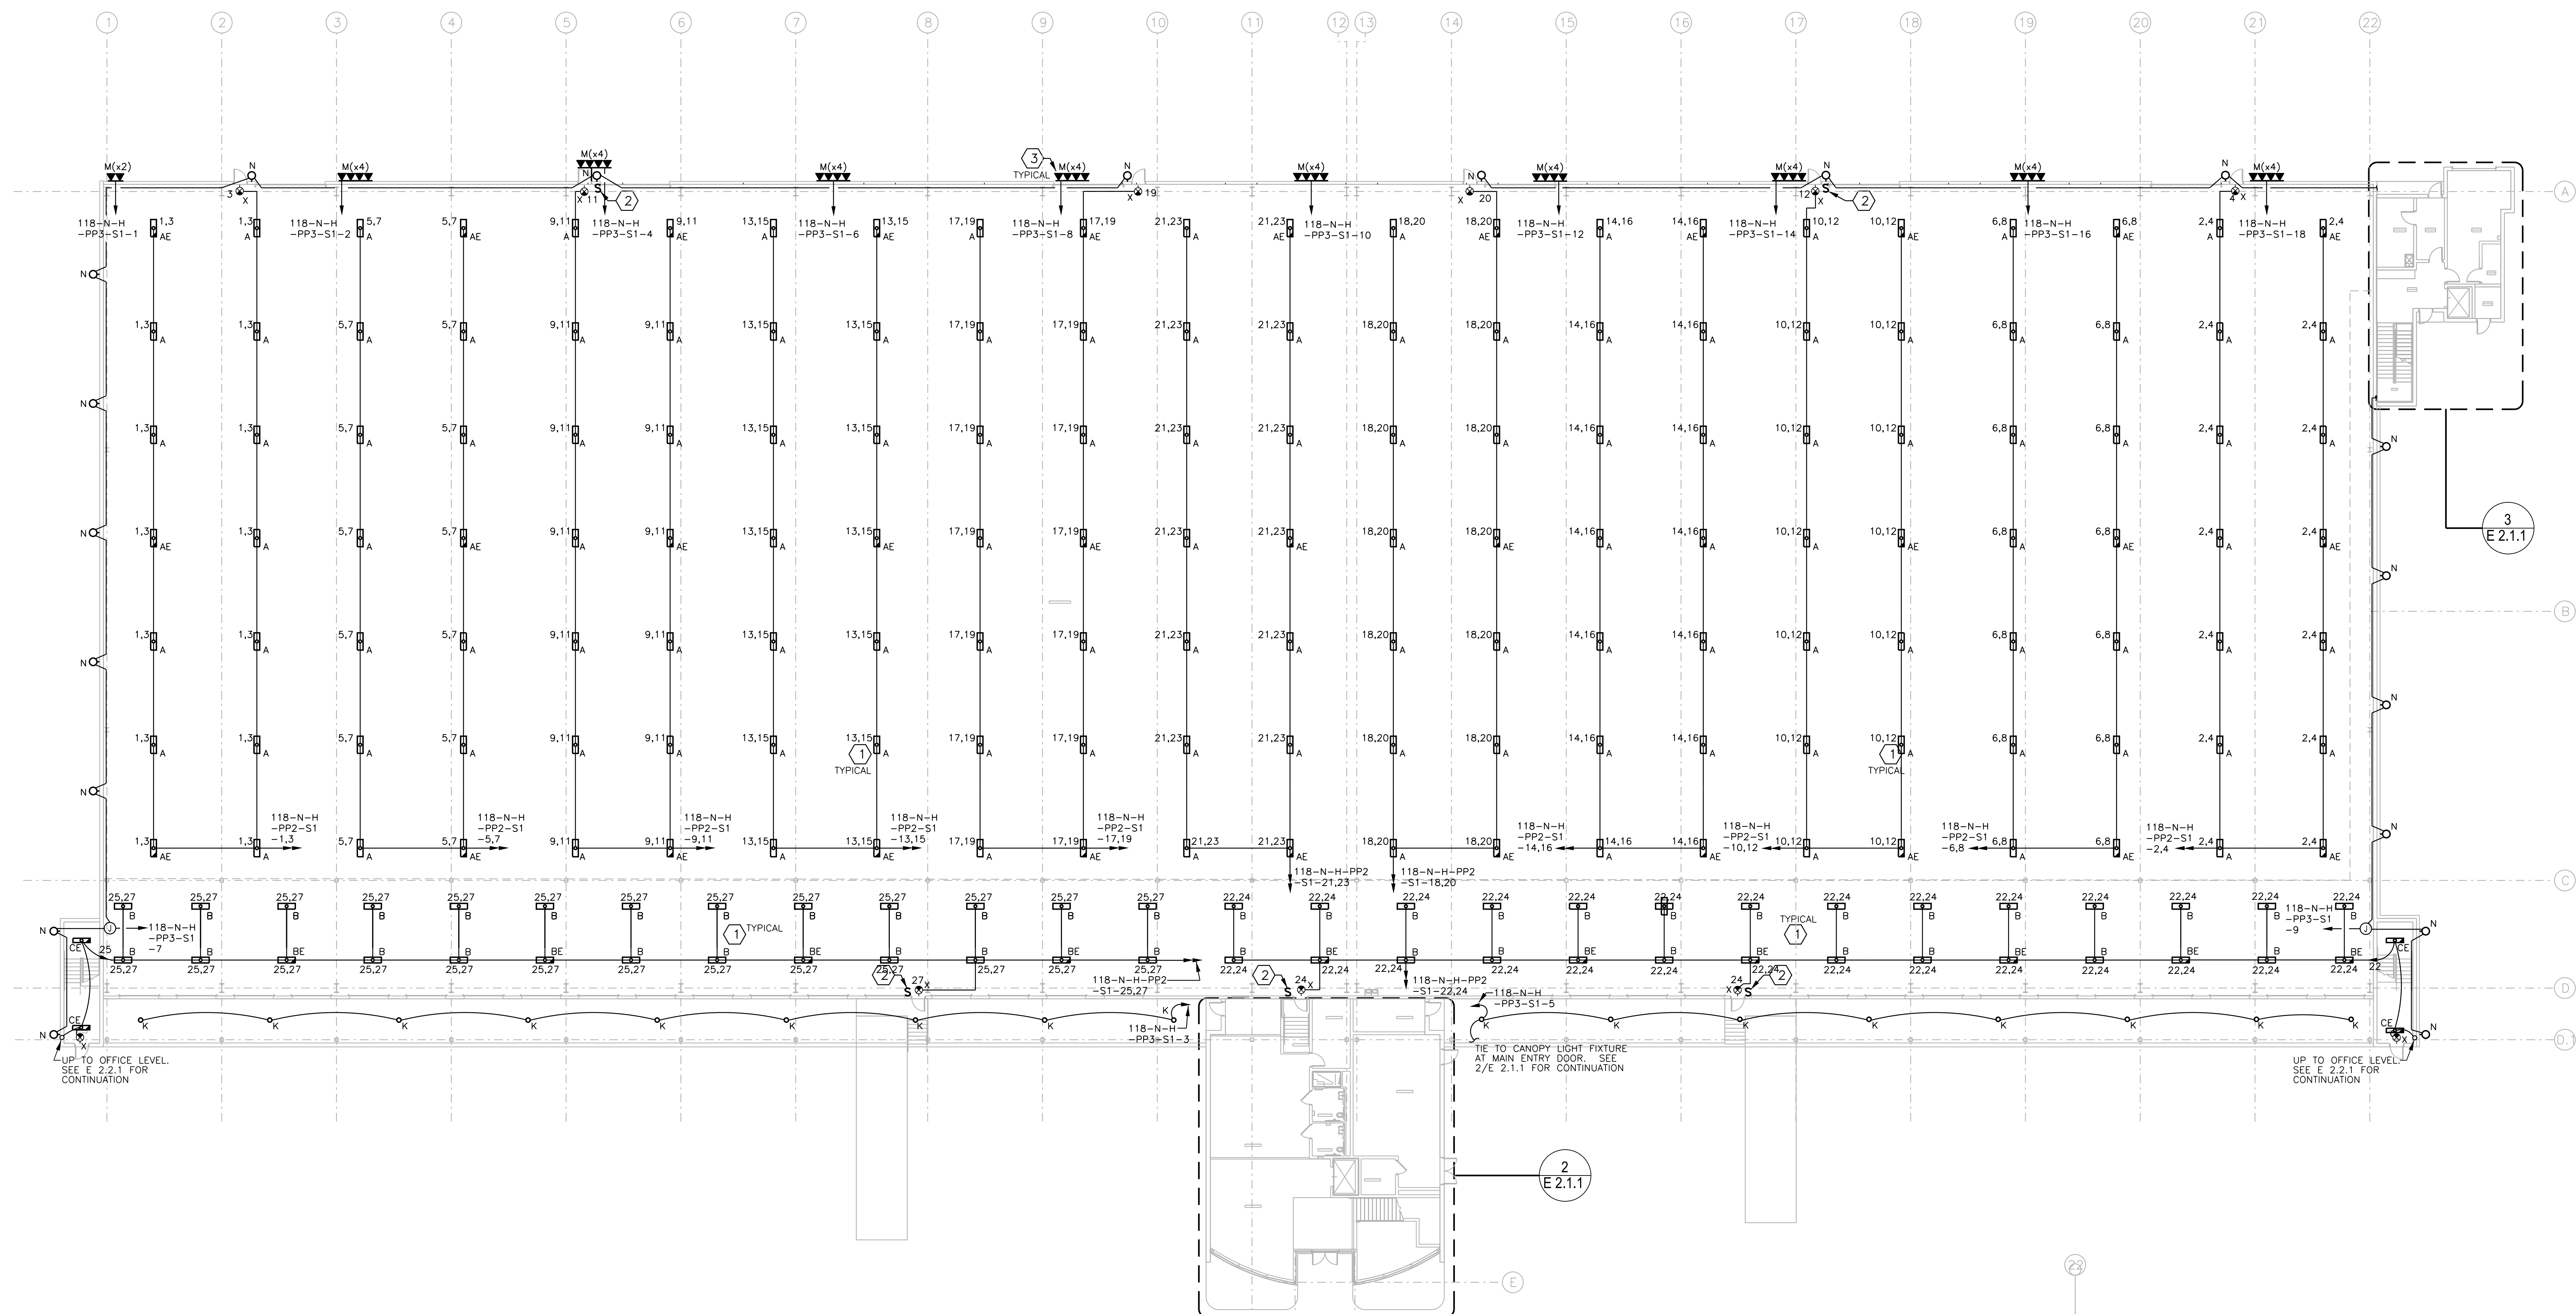


1  
E 2.1.1  
OPERATIONS LEVEL LIGHTING PLAN  
SCALE: 1/8"=1'-0"

GENERAL NOTES:


1. ALL EMERGENCY BATTERY INVERTER BALLASTED FIXTURES SHALL BE WIRED TO BE SWITCHED WITH THE NORMAL LIGHTING IN THE ROOM UNO.
2. PROVIDE UNSWITCHED BRANCH CIRCUIT CONDUCTOR TO ALL EXIT SIGNS AND EMERGENCY BATTERY INVERTER BALLASTS FOR CONTINUOUS CHARGING OF INVERTER.
3. ALL TYPE A, AE, B AND BE WAREHOUSE LIGHTING SHALL BE CONTROLLED THROUGH THE LIGHTING CONTROL SYSTEM VIA RELAY PANELS LOCATED ADJACENT TO THE POWER PANELBOARDS. ROUTE BRANCH CIRCUITS THROUGH INDIVIDUAL RELAYS.
4. ALL EXTERIOR LIGHTING SHALL BE CONTROLLED THROUGH THE LIGHTING CONTROL SYSTEM VIA RELAY PANELS LOCATED ADJACENT TO THE POWER PANELBOARDS. ROUTE BRANCH CIRCUITS THROUGH INDIVIDUAL RELAYS.

KEYED NOTES:


1. FIXTURE WITH TWO 277 VOLT BALLASTS. CONNECT FIRST CIRCUIT TO ONE BALLAST AND CONNECT SECOND CIRCUIT TO THE OTHER BALLAST. PROVIDE ADDITIONAL UNSWITCHED CONDUCTOR FROM SECOND CIRCUIT FOR CONNECTION TO BATTERY INVERTER CHARGER. (TYPICAL FOR ALL TYPE A, AE, B AND BE FIXTURES IN WAREHOUSE AREA).
2. LIGHTING CONTROL SYSTEM PUSHBUTTON OVERRIDE SWITCH LOCATION.
3. SEE STRUCTURAL DETAIL 12/S 7.0.1 FOR MOUNTING OF POLE TO BUILDING FOR ALL TYPE M FIXTURE LOCATIONS ALONG WEST BUILDING ELEVATION.

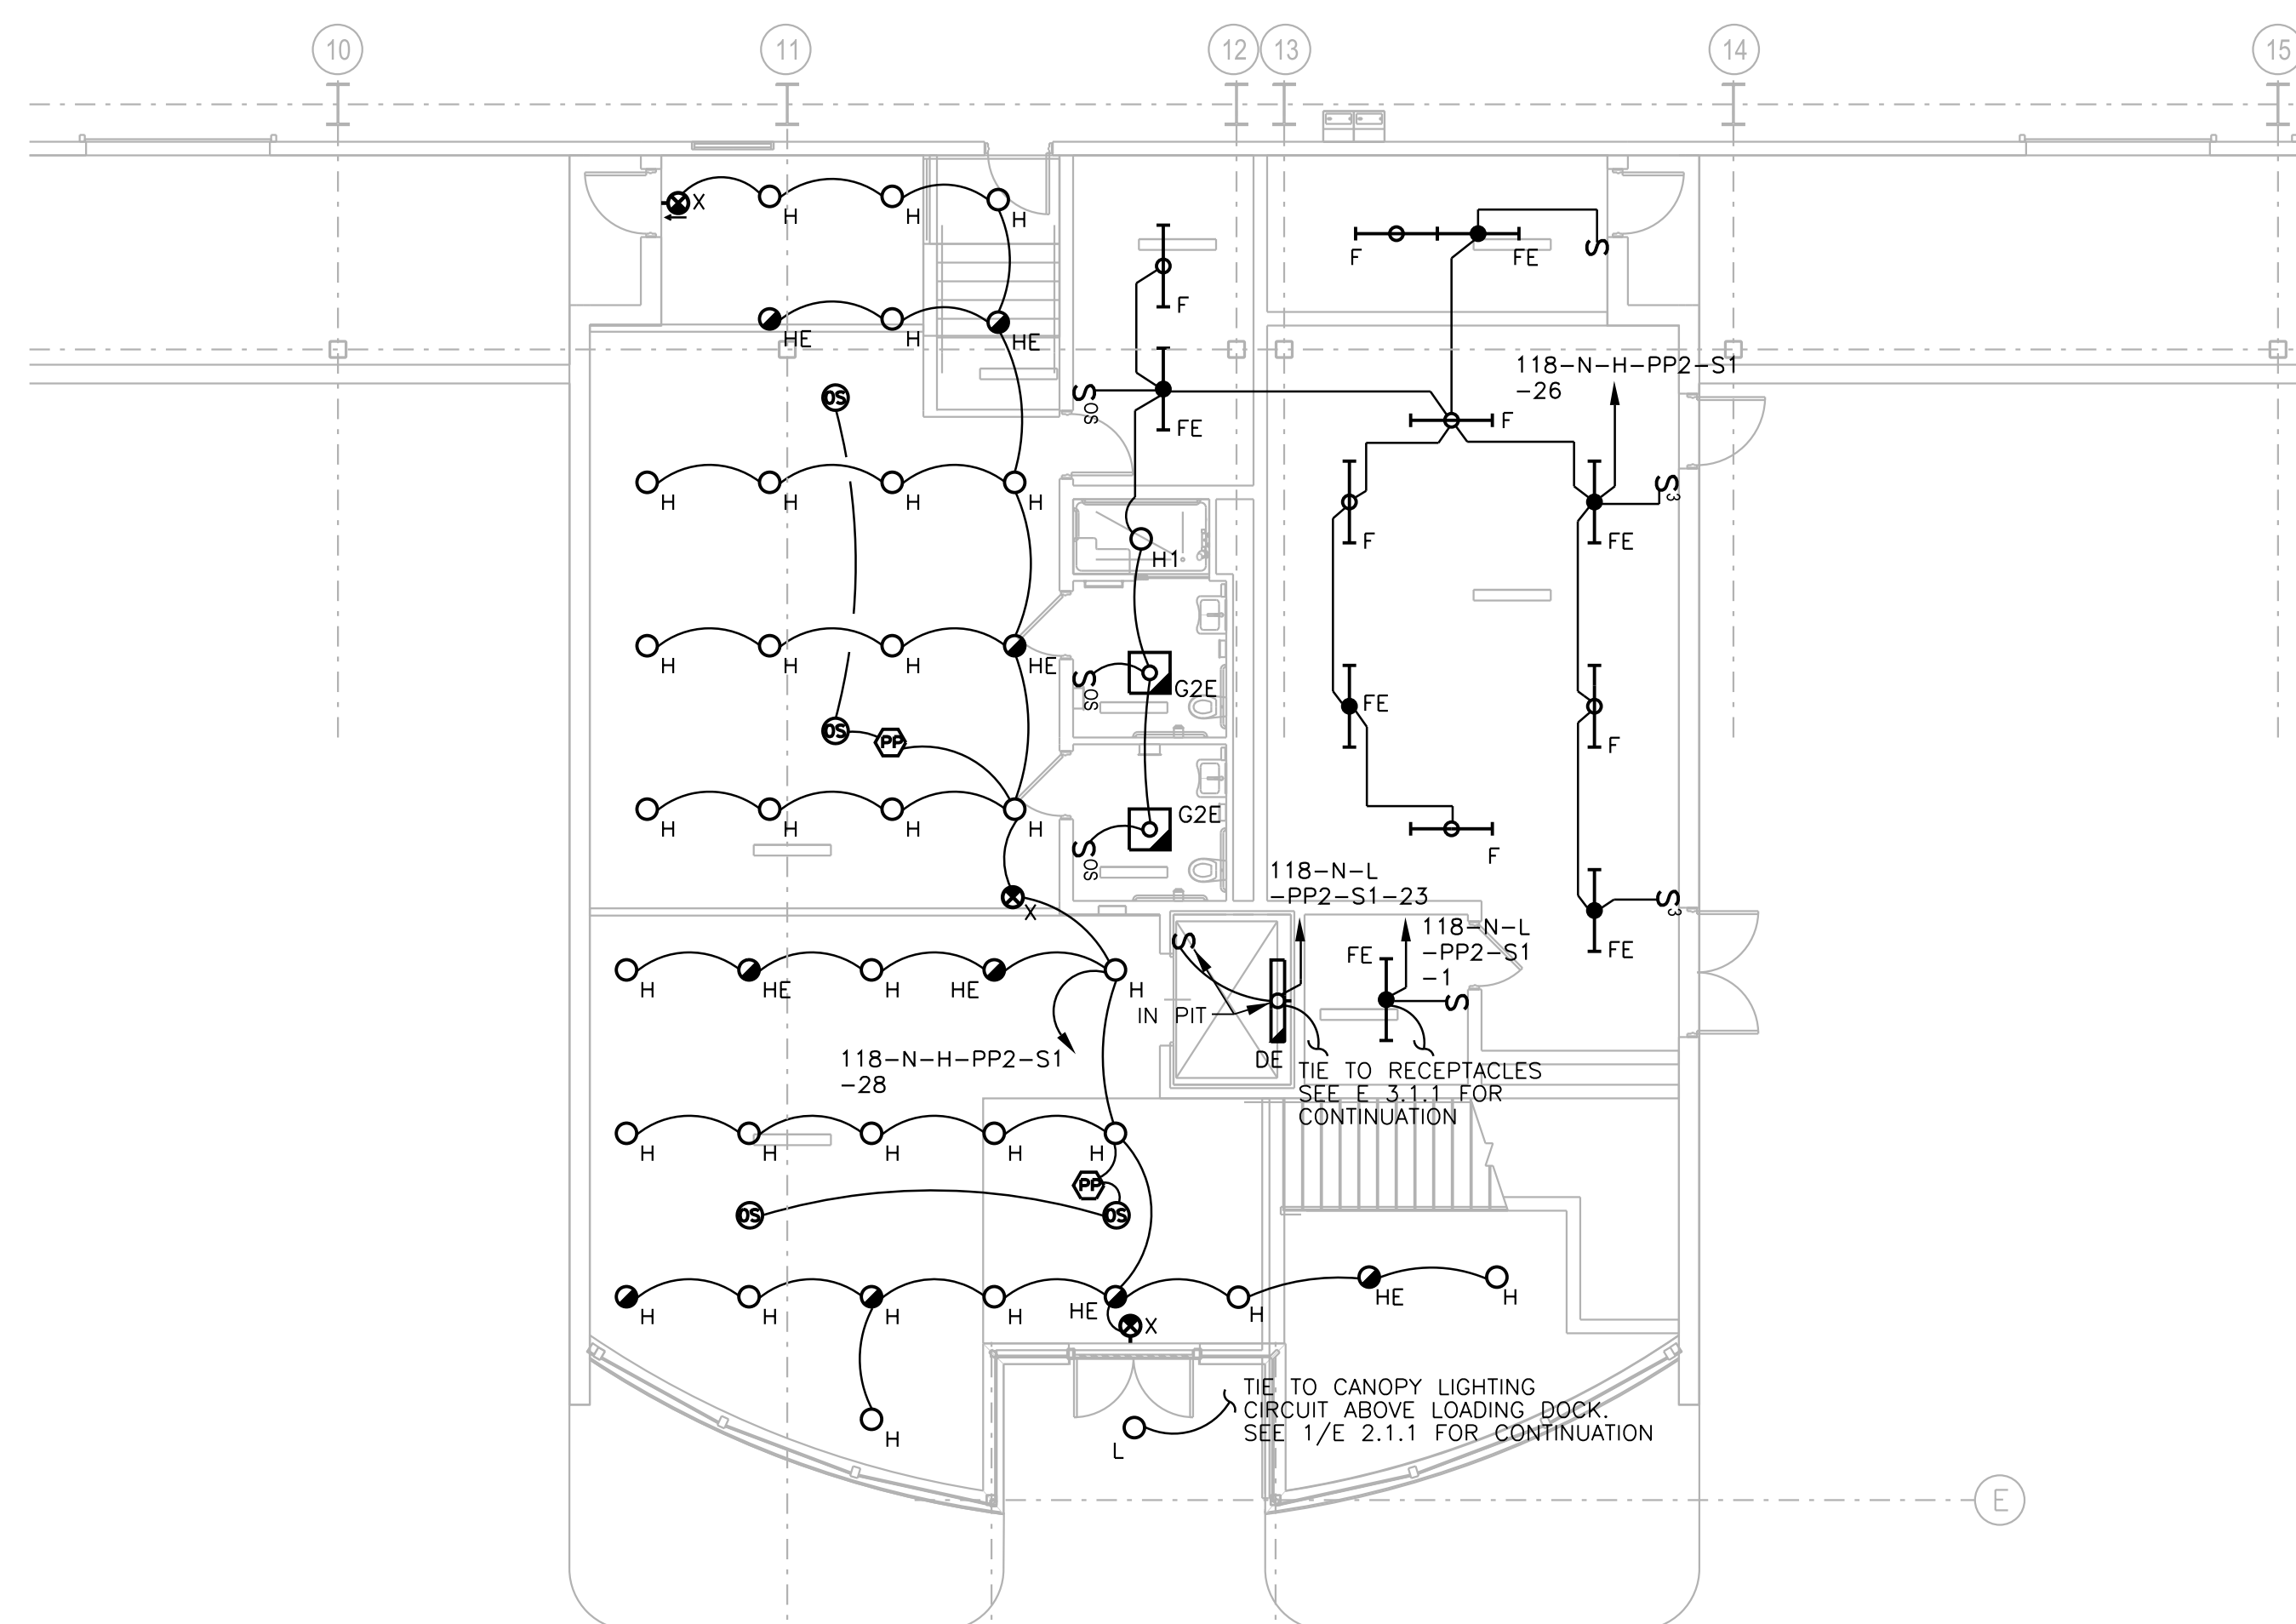

2  
E 2.1.1  
PART PLAN - OPERATIONS LEVEL OFFICE LIGHTING  
SCALE: 1/8"=1'-0"

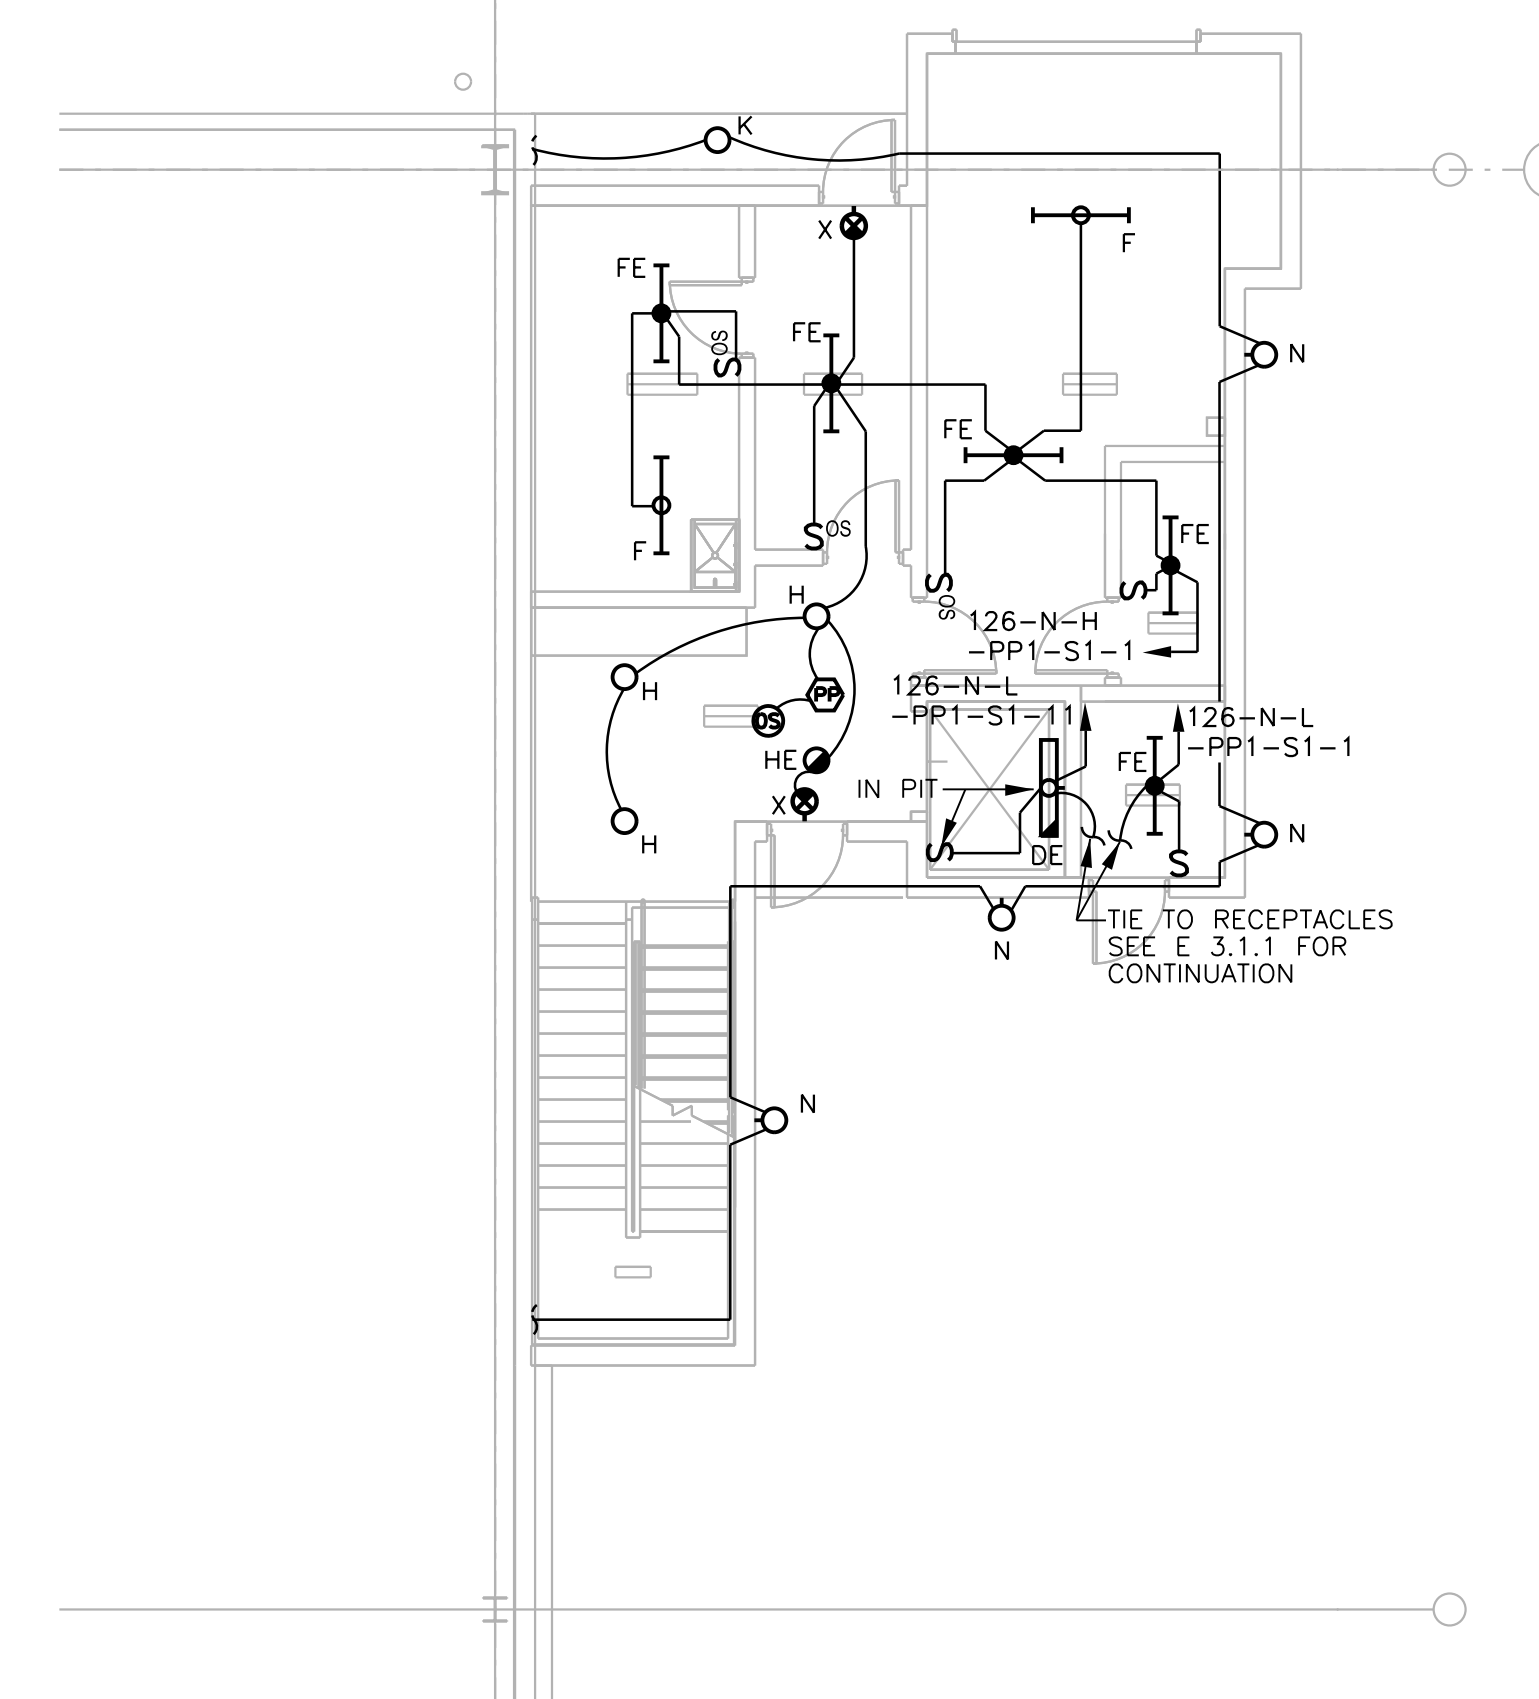

3  
E 2.1.1  
PART PLAN - OPERATIONS LEVEL DOA RAMP OPS LIGHTING  
SCALE: 1/8"=1'-0"

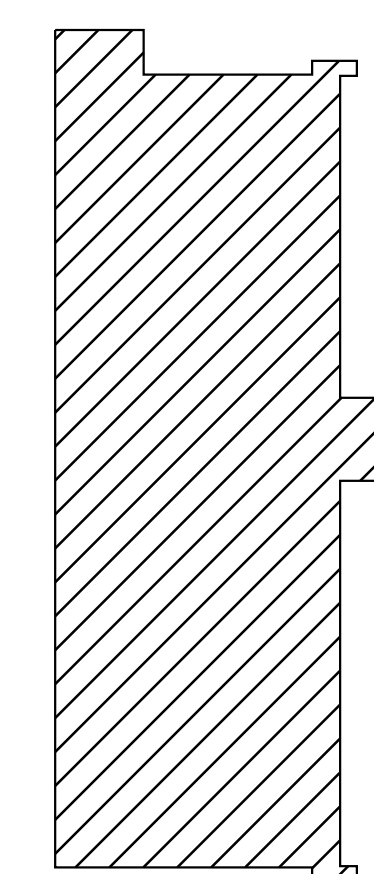

KEY MAP  
NORTH

NO. DATE BY REVISION

AIR CARGO BUILDING C

ELECTRICAL  
OPERATIONS LEVEL  
LIGHTING PLAN

WBS NUMBER:

D.07.55.009

FC NUMBER:

FC-6006007929-A

AE PROJECT NUMBER:

HI-0730621

DRAWN BY:

M. TRINKER

DESIGNED BY:

M. TRINKER

CHECKED BY:

S. SVEDA

APPROVED BY:

S. SVEDA

DATE:

11/25/2014

SCALE:

AS NOTED

SHEET NO.

E 2.1.1

NOT RELEASED FOR CONSTRUCTION





CITY OF ATLANTA, GEORGIA

Hartsfield-Jackson  
Atlanta International Airport

**HSST**


HEERY INTERNATIONAL, INC. 999  
PEACHTREE STREET, NE  
ATLANTA, GA 30309  
PHONE: 404.418.9190  
FAX: 404.582.2017

MATROX 3D  
44 BROAD STREET  
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FAX: 404.522.3803

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100 PEACHTREE STREET, SUITE 2000  
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PHONE: 404.522.8888  
FAX: 404.521.6204

SOUTHEASTERN ENGINEERING, INC. (SEI)  
201 SANDY PLAINS ROAD  
MARIETTA, GA 30066  
PHONE: 770.321.9308  
FAX: 770.321.3935

AIR CARGO BUILDING C, 100% CONSTRUCTION DOCUMENTS ISSUED FOR BID, NOVEMBER 25, 2014

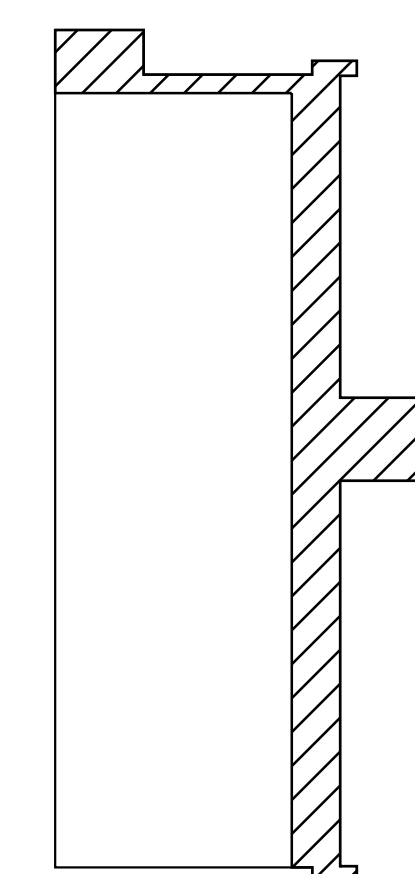

KEY MAP  
NORTH

NO. DATE BY REVISION

AIR CARGO BUILDING C

ELECTRICAL  
OFFICE LEVEL  
LIGHTING PLAN

WBS NUMBER:

D.07.55.009

FC NUMBER:

FC-6006007529-A

A/E PROJECT NUMBER:

HII-0730621

DRAWN BY:

M. TRINKER

DESIGNED BY:

M. TRINKER

CHECKED BY:

S. SVEDA

APPROVED BY:

S. SVEDA

DATE:

11/25/2014

SCALE:


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SHEET NO.

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SEAL


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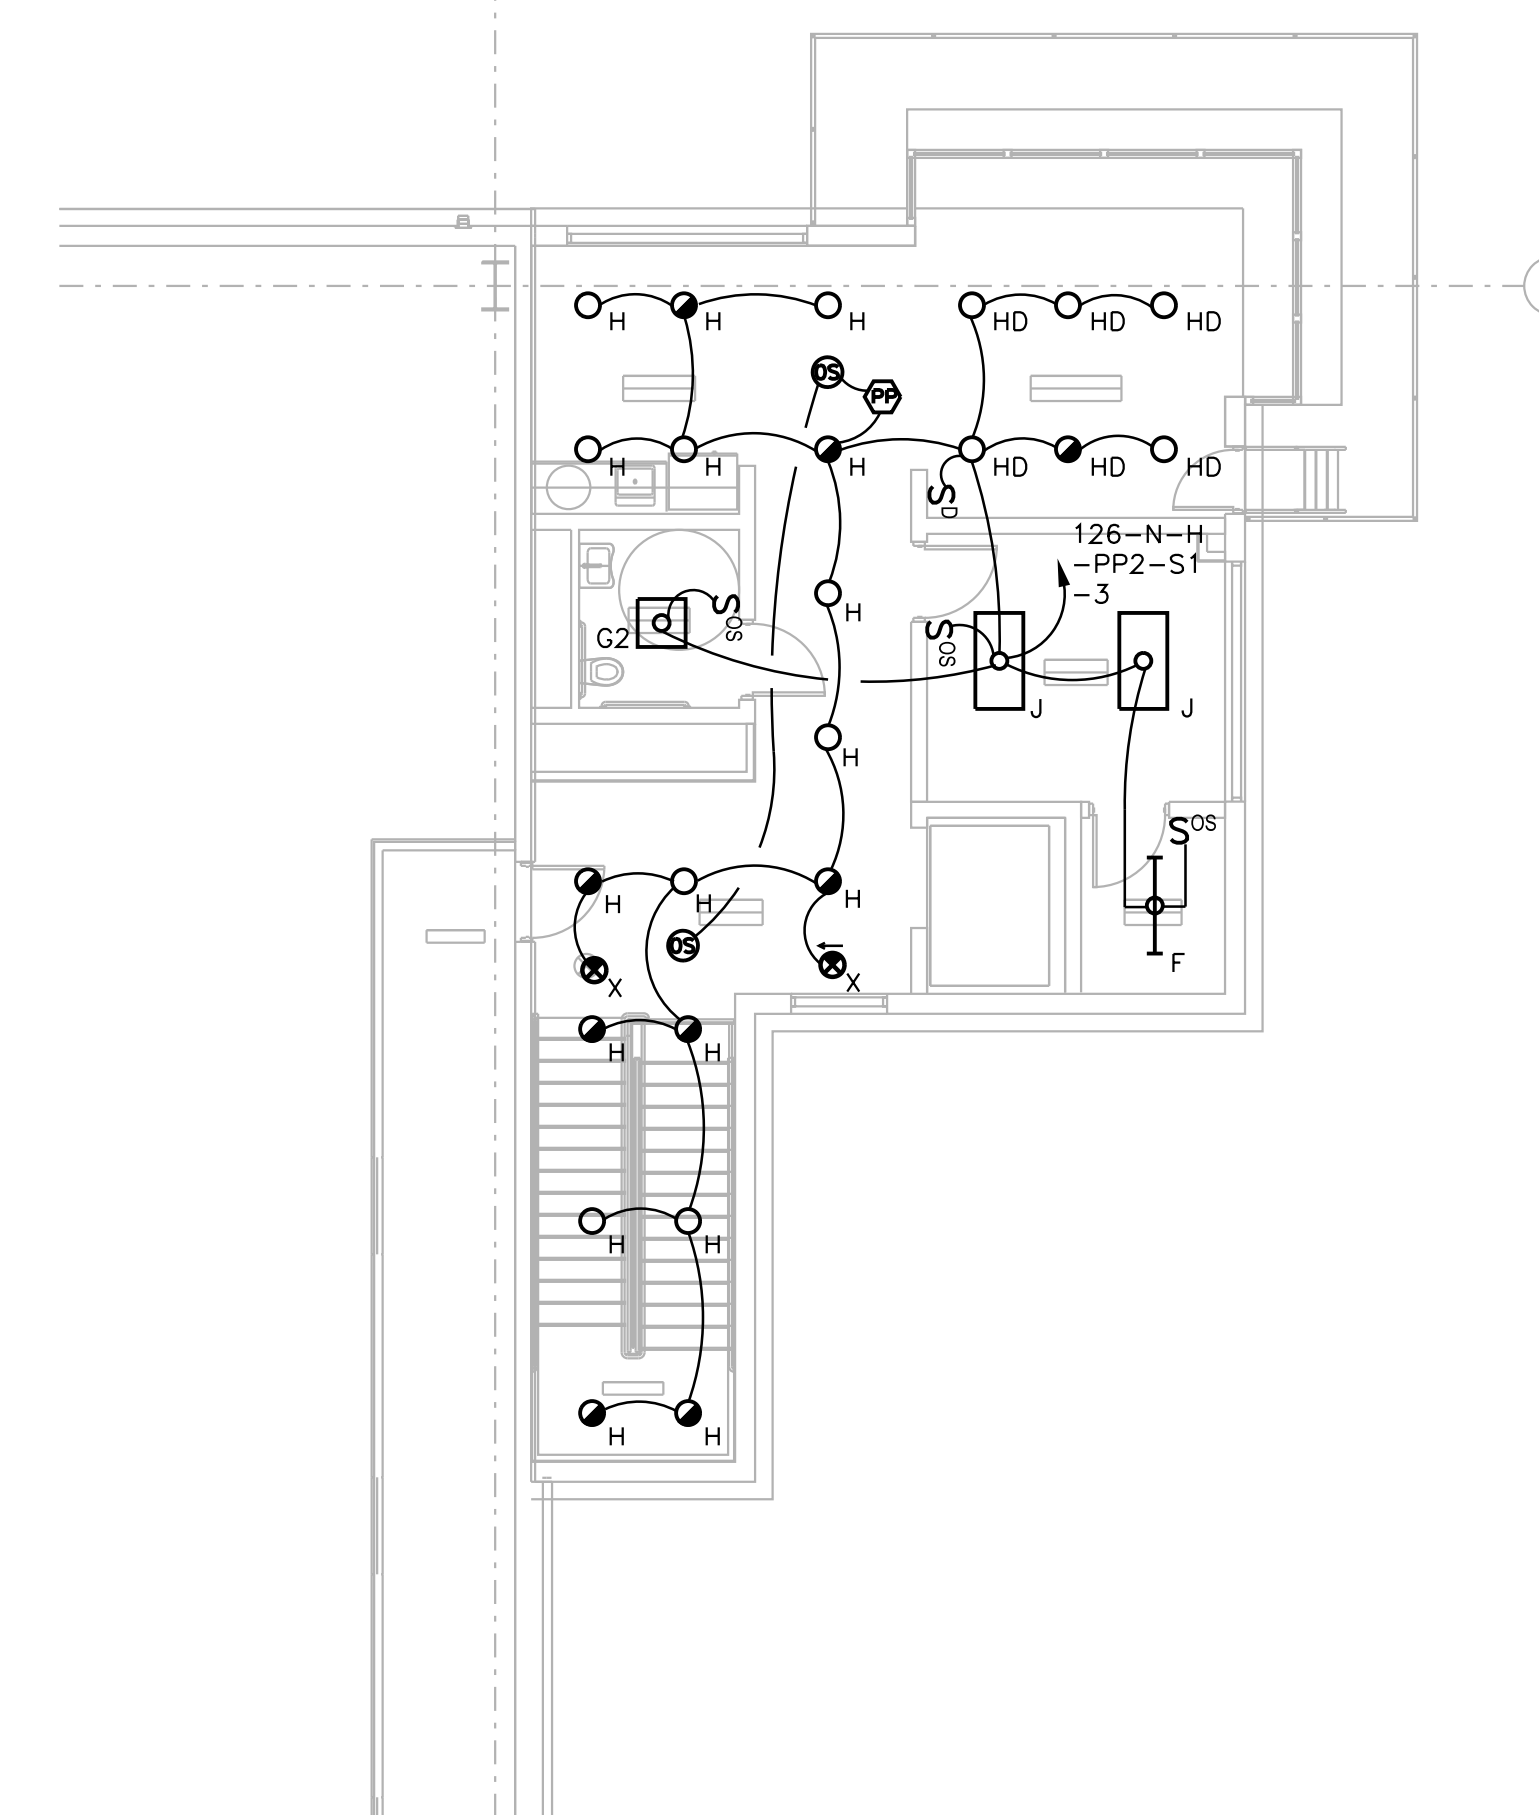
1  
E 2.2.1  
OFFICE LEVEL LIGHTING PLAN  
SCALE: 1/8"=1'-0"

GENERAL NOTES:


1. ALL EMERGENCY BATTERY INVERTER BALLASTED FIXTURES SHALL BE WIRED TO BE SWITCHED WITH THE NORMAL LIGHTING IN THE ROOM UNO.
2. PROVIDE UNSWITCHED BRANCH CIRCUIT CONDUCTOR TO ALL EXIT SIGNS AND EMERGENCY BATTERY INVERTER BALLASTS FOR CONTINUOUS CHARGING OF INVERTER.
3. ALL EXTERIOR LIGHTING SHALL BE CONTROLLED THROUGH THE LIGHTING CONTROL SYSTEM VIA RELAY PANELS LOCATED ADJACENT TO THE POWER PANELBOARDS. ROUTE BRANCH CIRCUITS THROUGH INDIVIDUAL RELAYS.

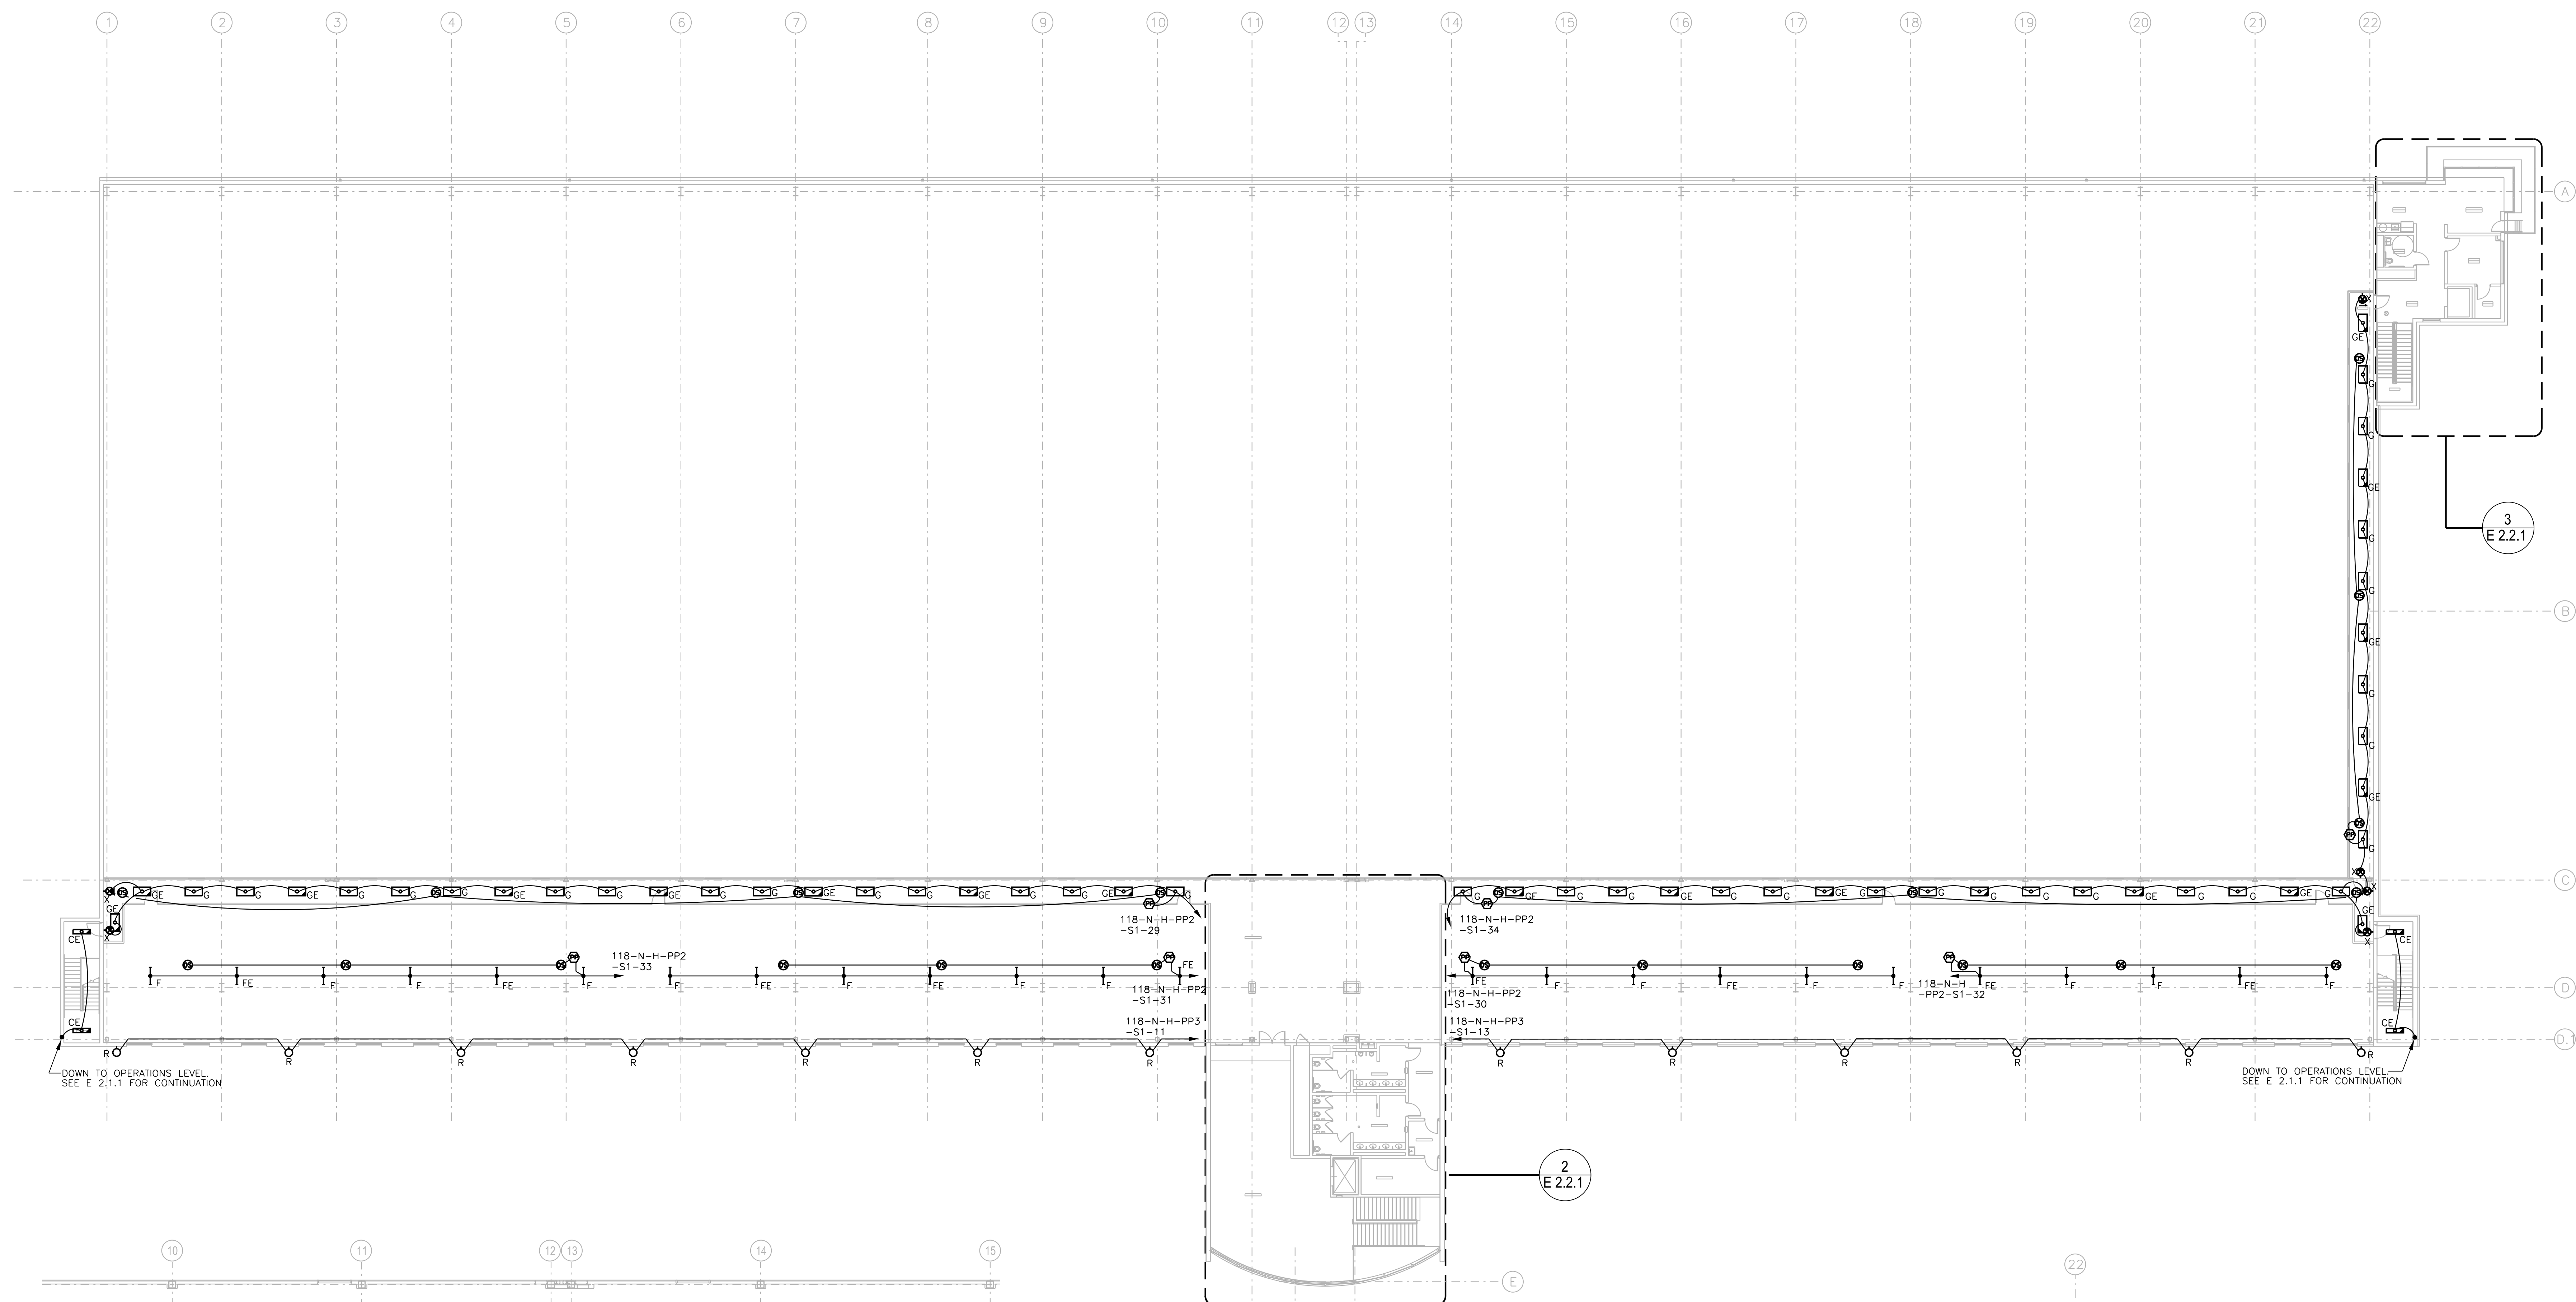

2  
E 2.2.1  
PART PLAN - OFFICE LEVEL OFFICE LIGHTING  
SCALE: 1/8"=1'-0"

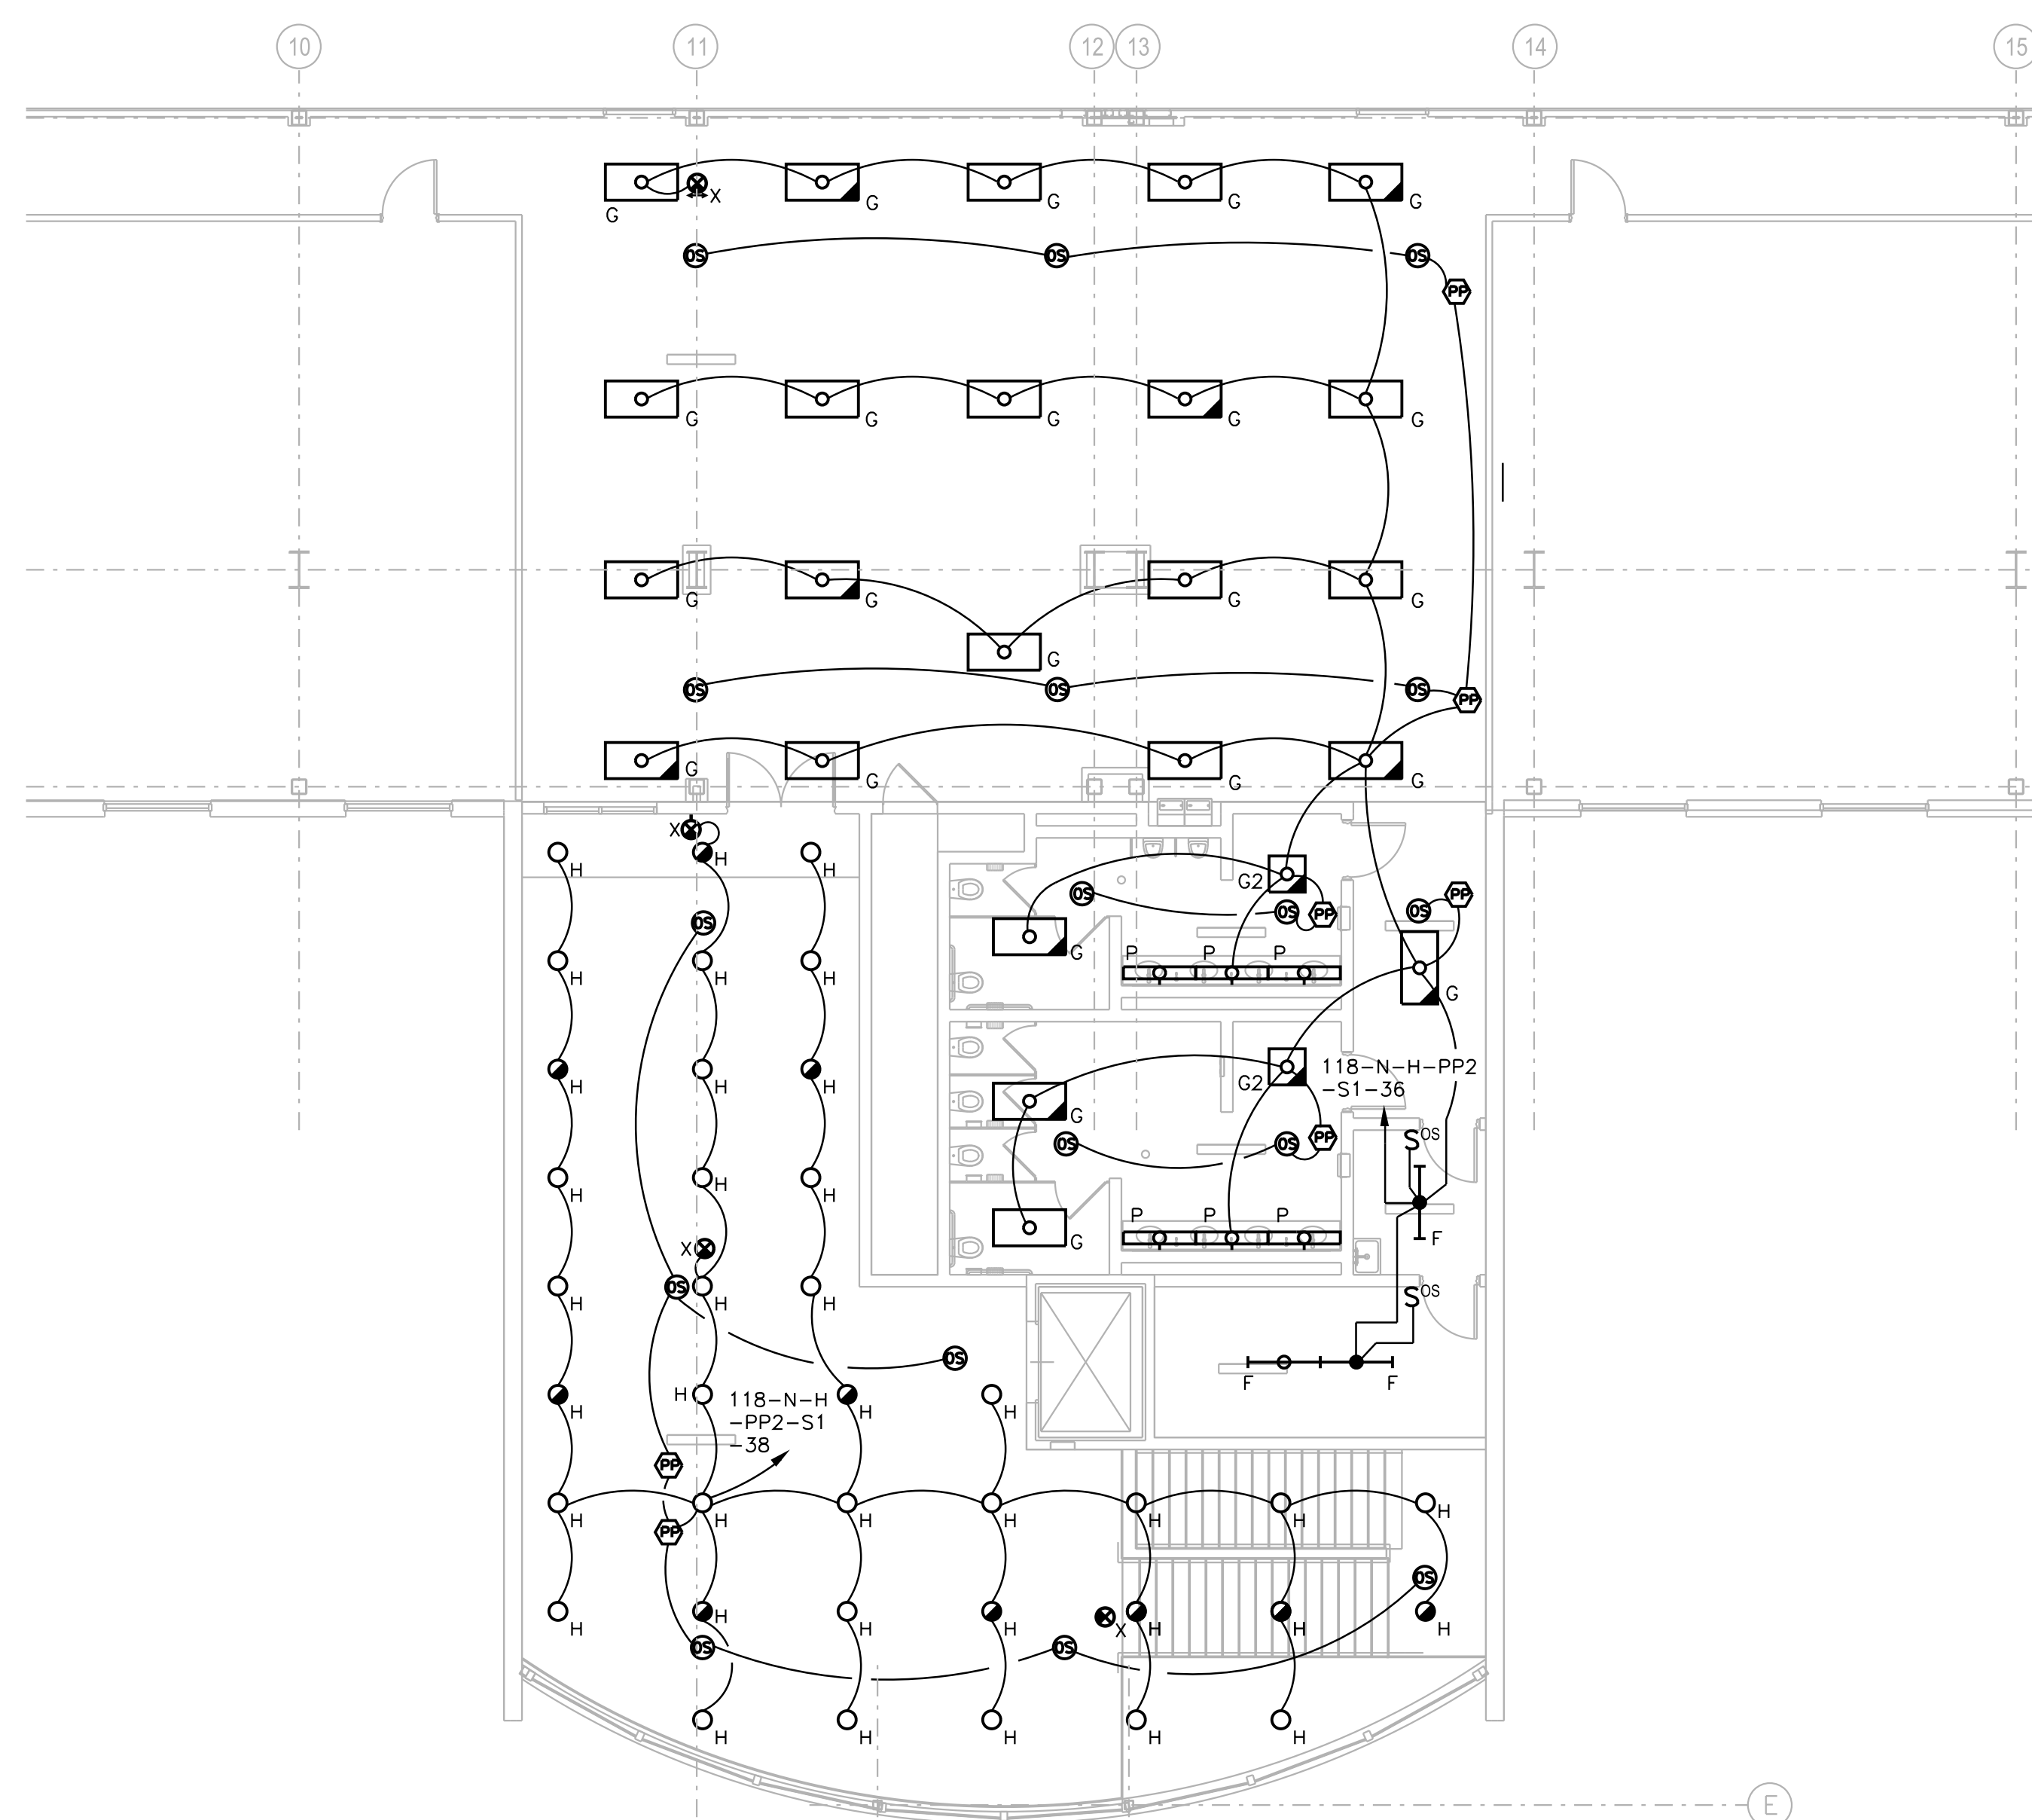

3  
E 2.2.1  
PART PLAN - OFFICE LEVEL DOA RAMP OPS LIGHTING  
SCALE: 1/8"=1'-0"

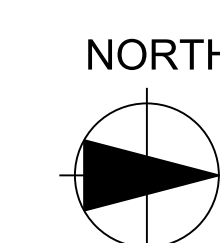





CITY OF ATLANTA, GEORGIA

Hartsfield-Jackson  
Atlanta International Airport




HEERY INTERNATIONAL, INC. 999  
PEACHTREE STREET, NE  
ATLANTA, GA 30309  
PHONE: 404.418.9190  
FAX: 404.846.2017

MATROX 3D  
44 BROAD STREET  
ATLANTA, GA 30303  
PHONE: 404.522.3801  
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STEVENS & VANDERSON, INC.  
100 PEACHTREE STREET, SUITE 2000  
ATLANTA, GA 30309  
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SOUTHEASTERN ENGINEERING, INC. (SEI)  
401 SANDY PLAINS ROAD  
MARIETTA, GA 30066  
PHONE: 770.321.9308  
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AIR CARGO BUILDING C, 100% CONSTRUCTION DOCUMENTS ISSUED FOR BID, NOVEMBER 25, 2014




1 OPERATIONS LEVEL POWER PLAN  
SCALE: 1/16"=1'-0"

GENERAL NOTES:

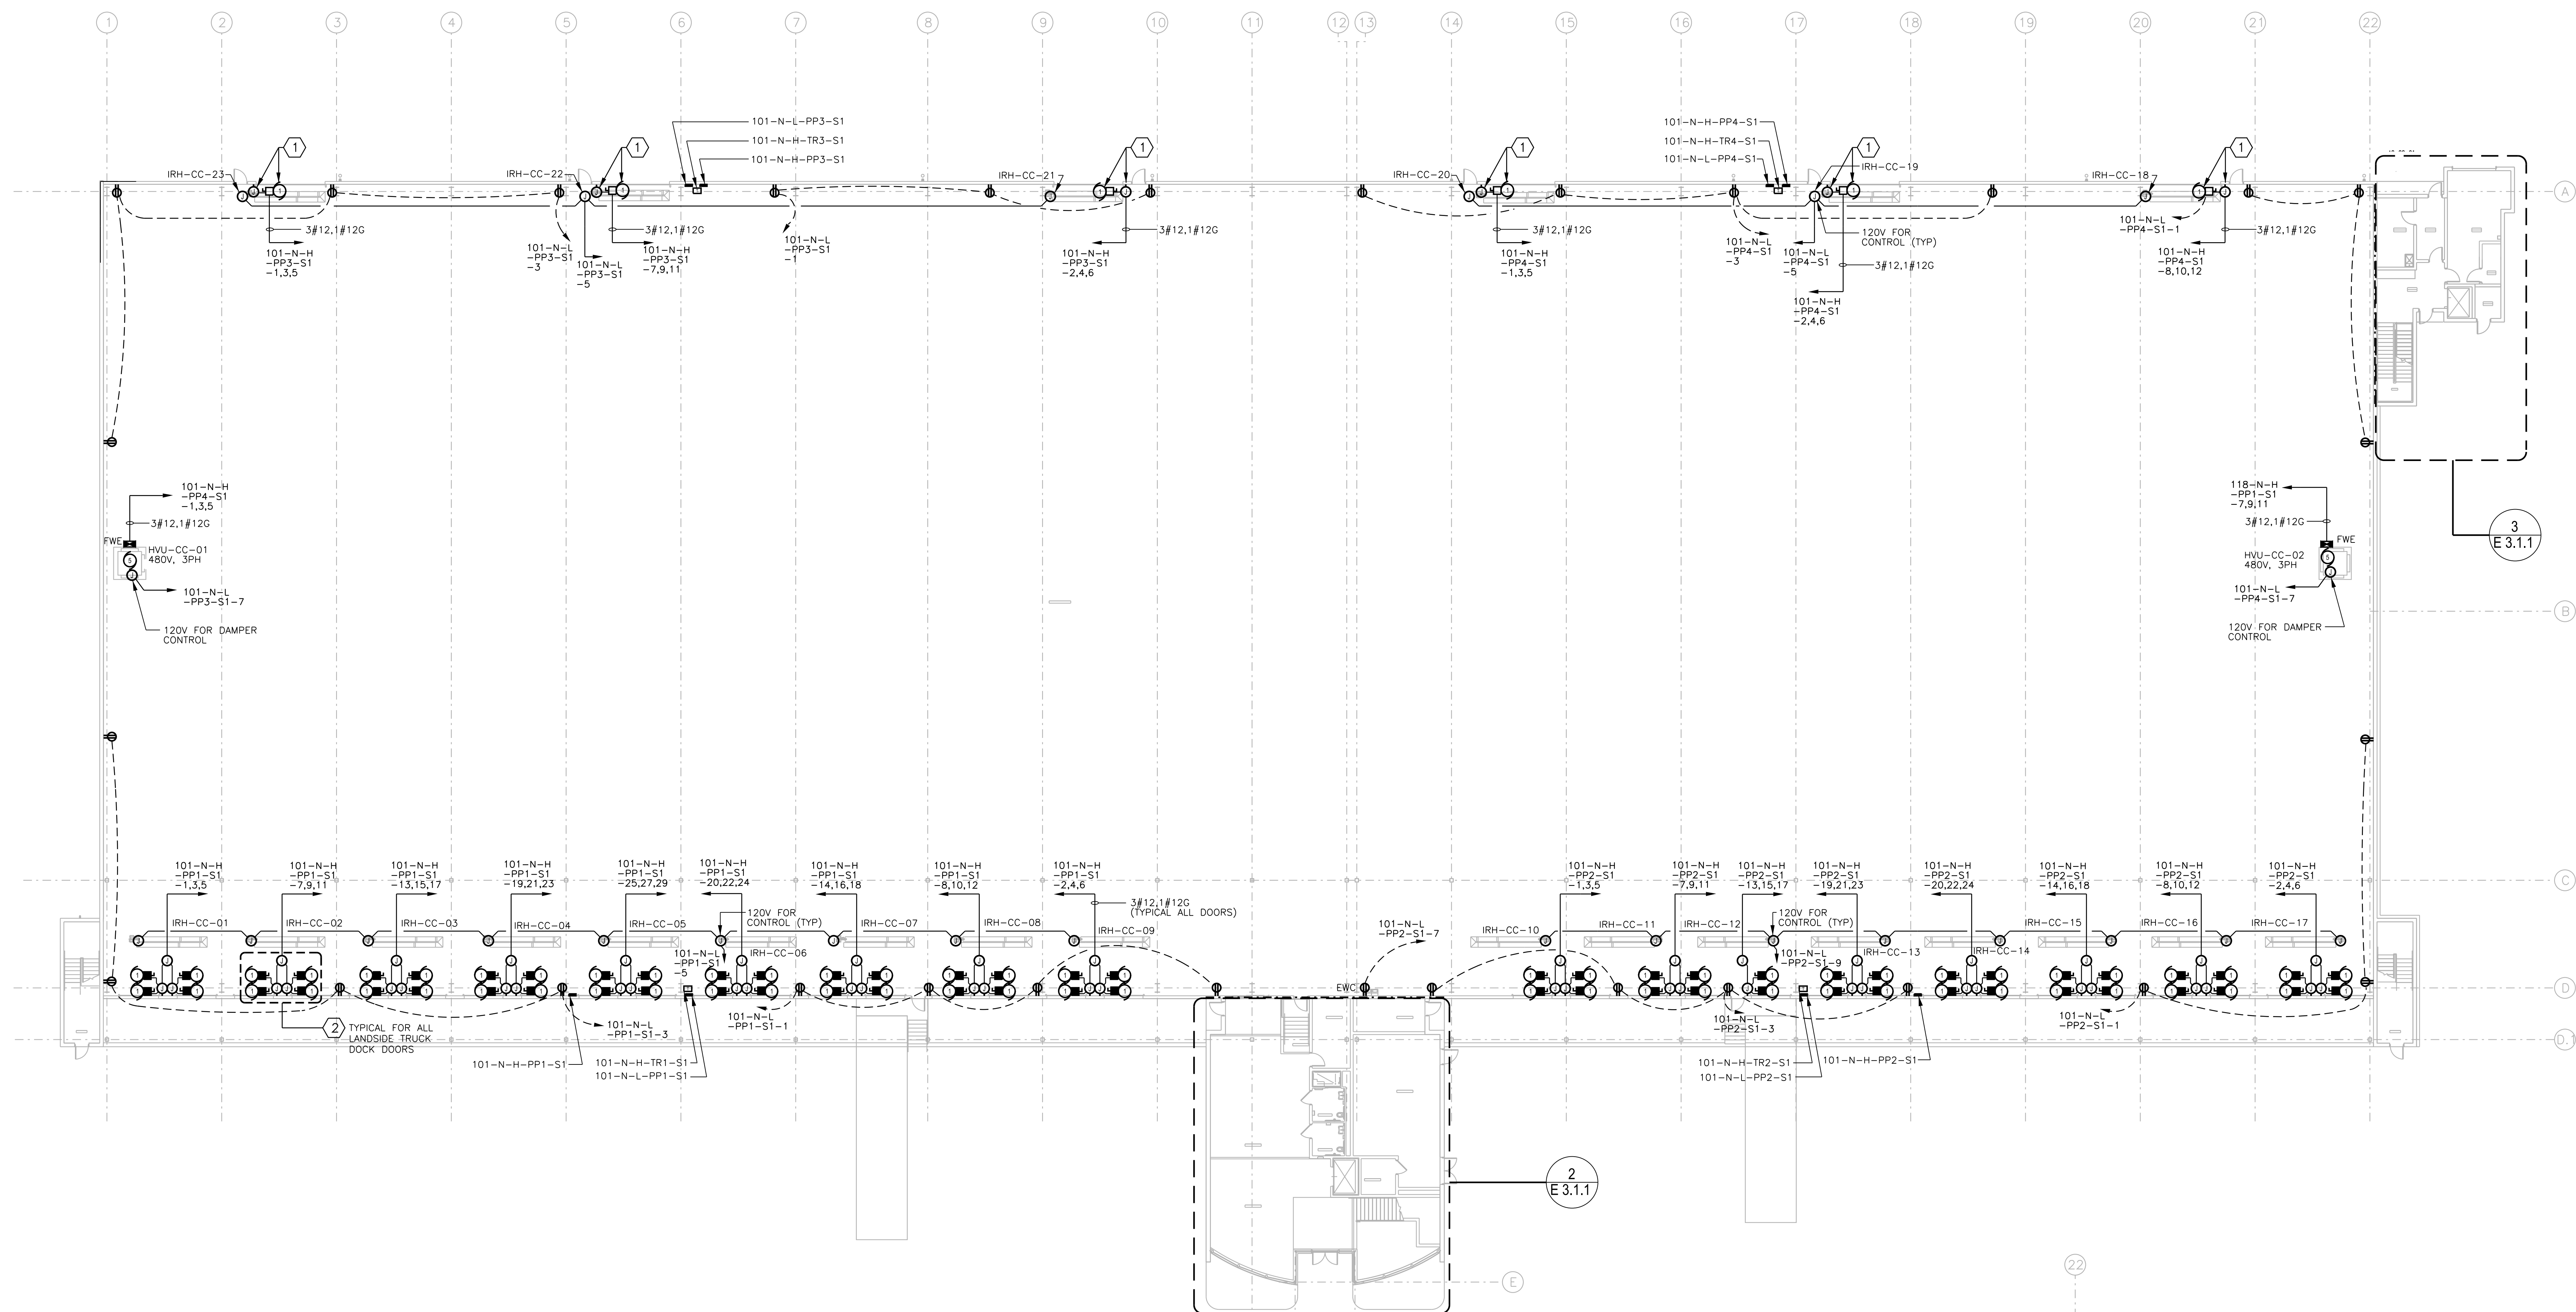
- ALL 120 VOLT BRANCH CIRCUITS LOCATED IN WAREHOUSE AREA 101 SHOWN ON OPERATIONS LEVEL POWER PLAN 1/E 3.1.1 SHALL BE #10 AWG MINIMUM SIZE WIRE THROUGHOUT THE BRANCH CIRCUIT.
- ALL HVAC STARTERS AND DISCONNECT SWITCHES ARE TYPICALLY PROVIDED WITH EQUIPMENT BY DIVISION 23. COORDINATE WITH HVAC EQUIPMENT SCHEDULES ON SHEET M 6.6.1 FOR REQUIREMENTS. WHERE FUSE SIZES ARE INDICATED, PROVIDE UNDER DIVISION 26.

KEYED NOTES:


- OVERHEAD DOOR WITH PUSHBUTTON DOOR CONTROL STATION (PROVIDED WITH EQUIPMENT) MOUNTED TO WALL AT 48" AFF. WIRE AS DIRECTED BY MANUFACTURER.
- CONNECTION TO OVERHEAD DOOR AND DOCK LEVELER EQUIPMENT. SEE CONNECTION DETAIL 1/E 9.1.1 FOR CONNECTION REQUIREMENTS.
- TIE TO ELEVATOR MACHINE ROOM/PIT LIGHT CIRCUITS. SEE SHEET E 2.2.1 FOR CONTINUATION.
- GFI RECEPTACLE DEDICATED FOR CONNECTION OF PIT SUMP PUMP SYSTEM.
- LIGHTING CONTROL SYSTEM MASTER CONTROLLER.

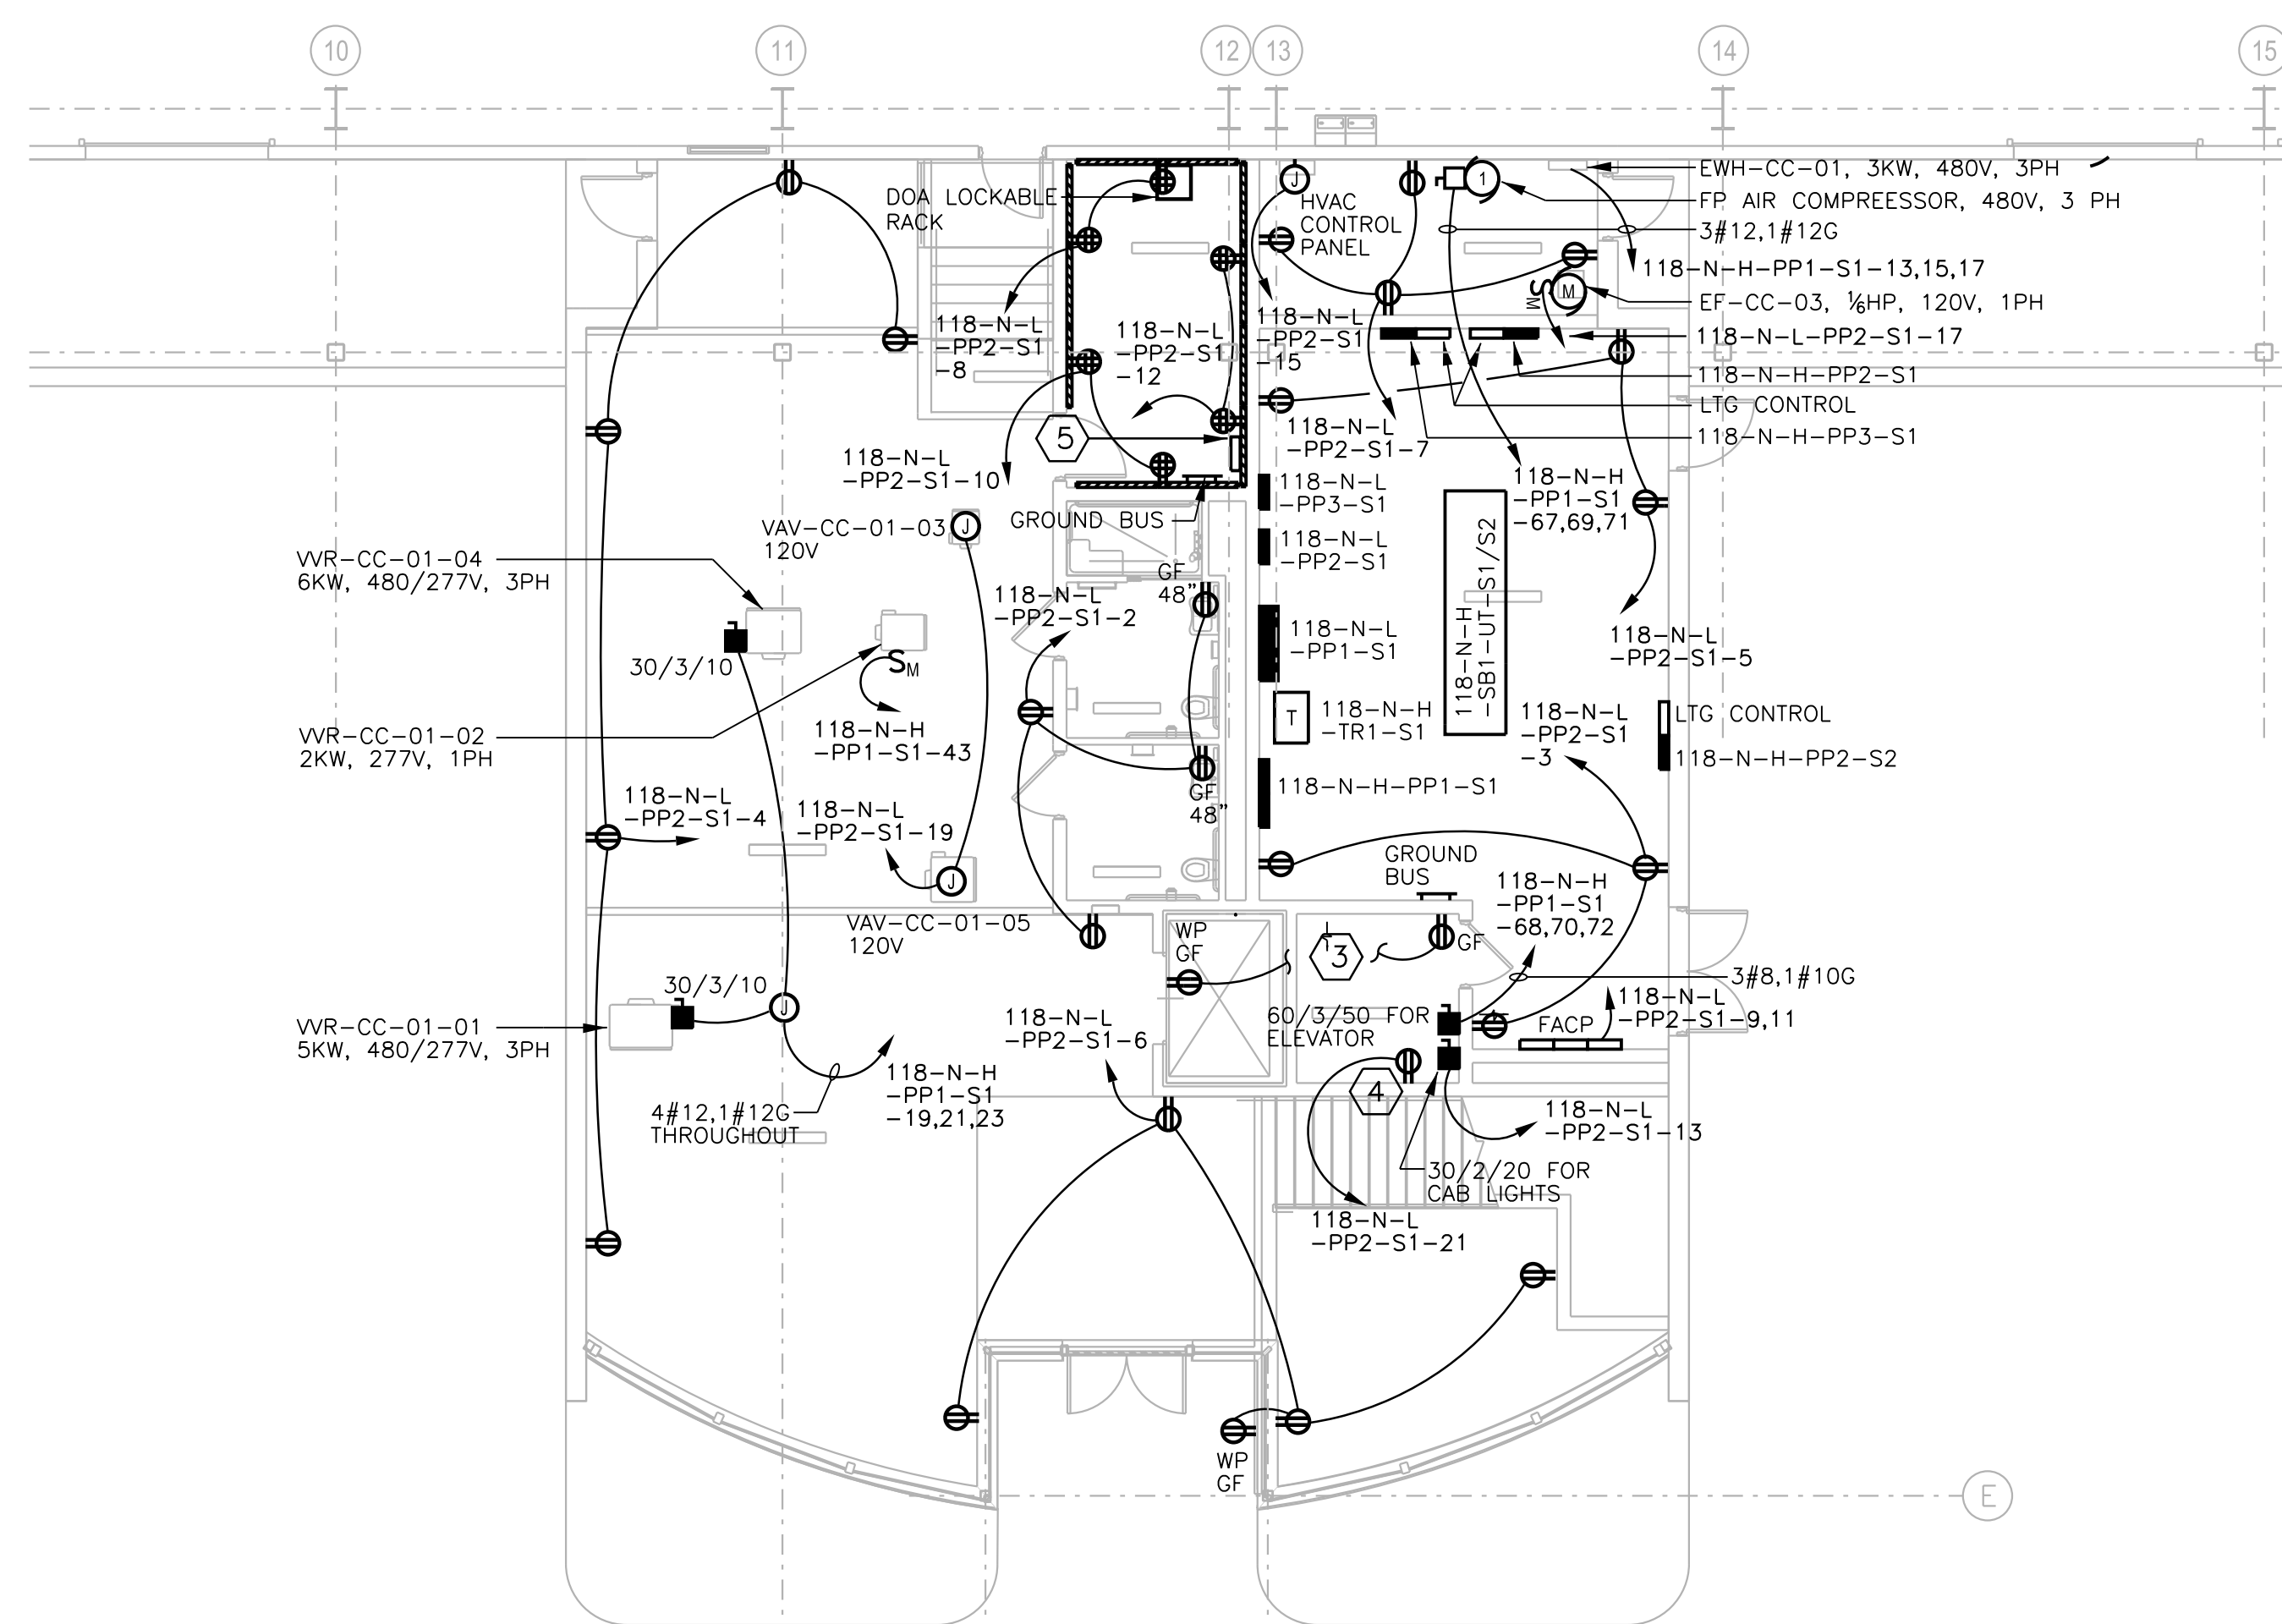

2 PART PLAN - OPERATIONS LEVEL OFFICE POWER  
SCALE: 1/8"=1'-0"

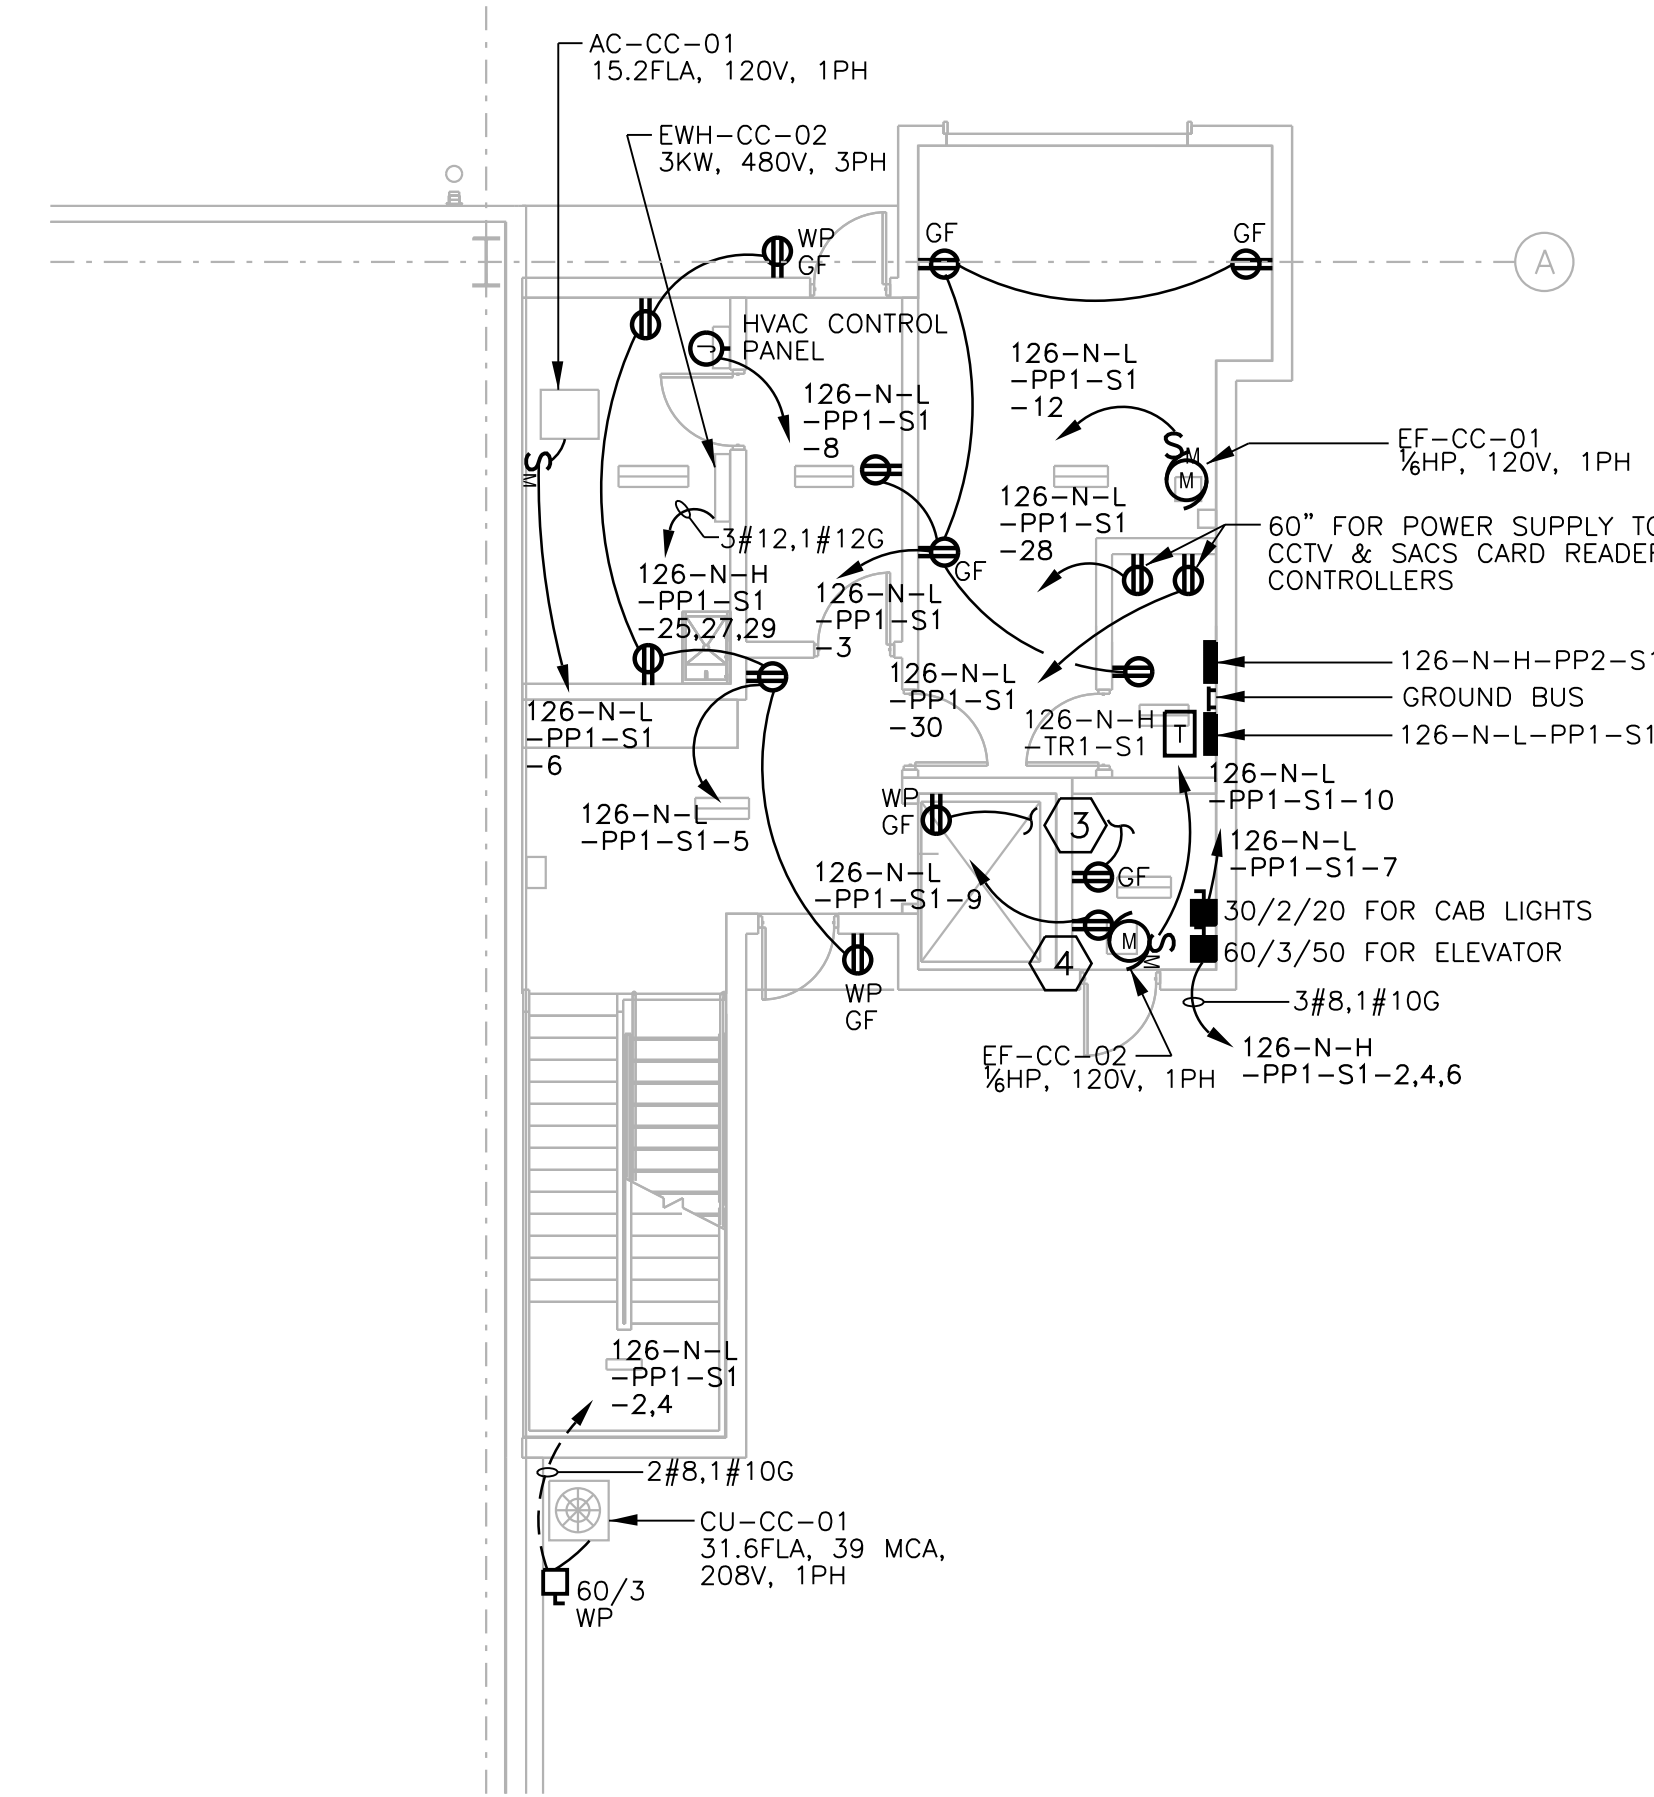

3 PART PLAN - OPERATIONS LEVEL DOA RAMP OPS POWER  
SCALE: 1/8"=1'-0"

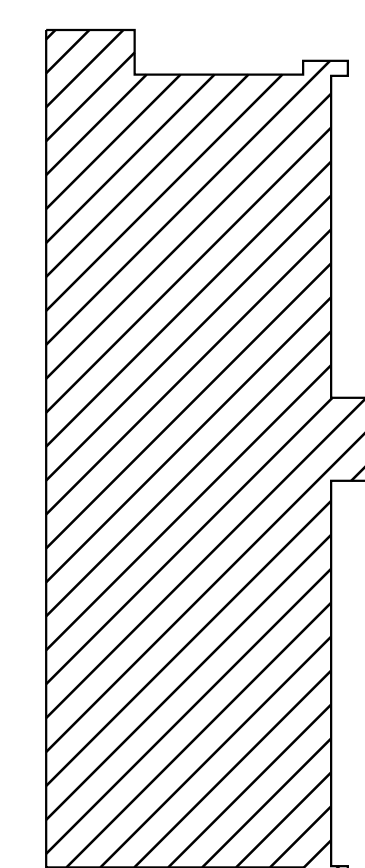

KEY MAP  
NORTH

NO. DATE BY REVISION

AIR CARGO BUILDING C

ELECTRICAL  
OPERATIONS LEVEL  
POWER PLAN

WBS NUMBER:

D.07.55.009

FC NUMBER:

FC-6006007929-A

AE PROJECT NUMBER:

HII-0730621

APPROVED BY:

S. SVEDA

DATE:

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SCALE:

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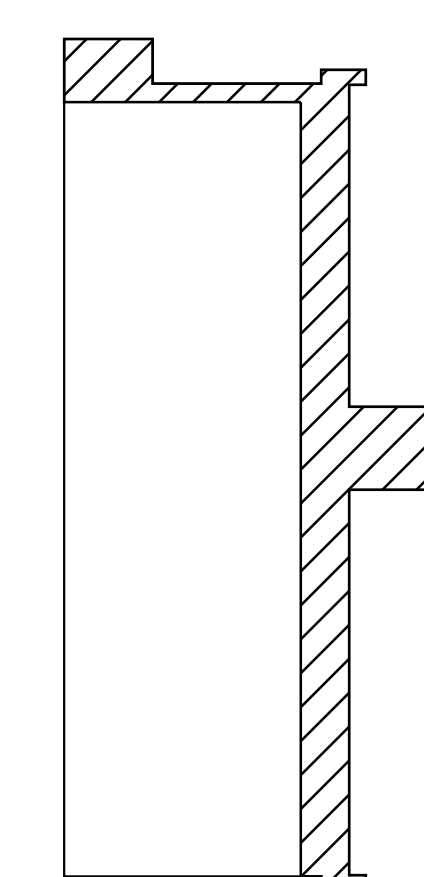
HEERY INTERNATIONAL, INC. 999  
PEACHTREE STREET, NE  
ATLANTA, GA 30309  
PHONE: 404.511.9190  
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AIR CARGO BUILDING C, 100% CONSTRUCTION DOCUMENTS ISSUED FOR BID, NOVEMBER 25, 2014



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ELECTRICAL  
OFFICE LEVEL  
POWER PLAN

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11/25/2014


SCALE:

AS NOTED

SHEET NO:

E 3.2.1

NOT RELEASED FOR CONSTRUCTION

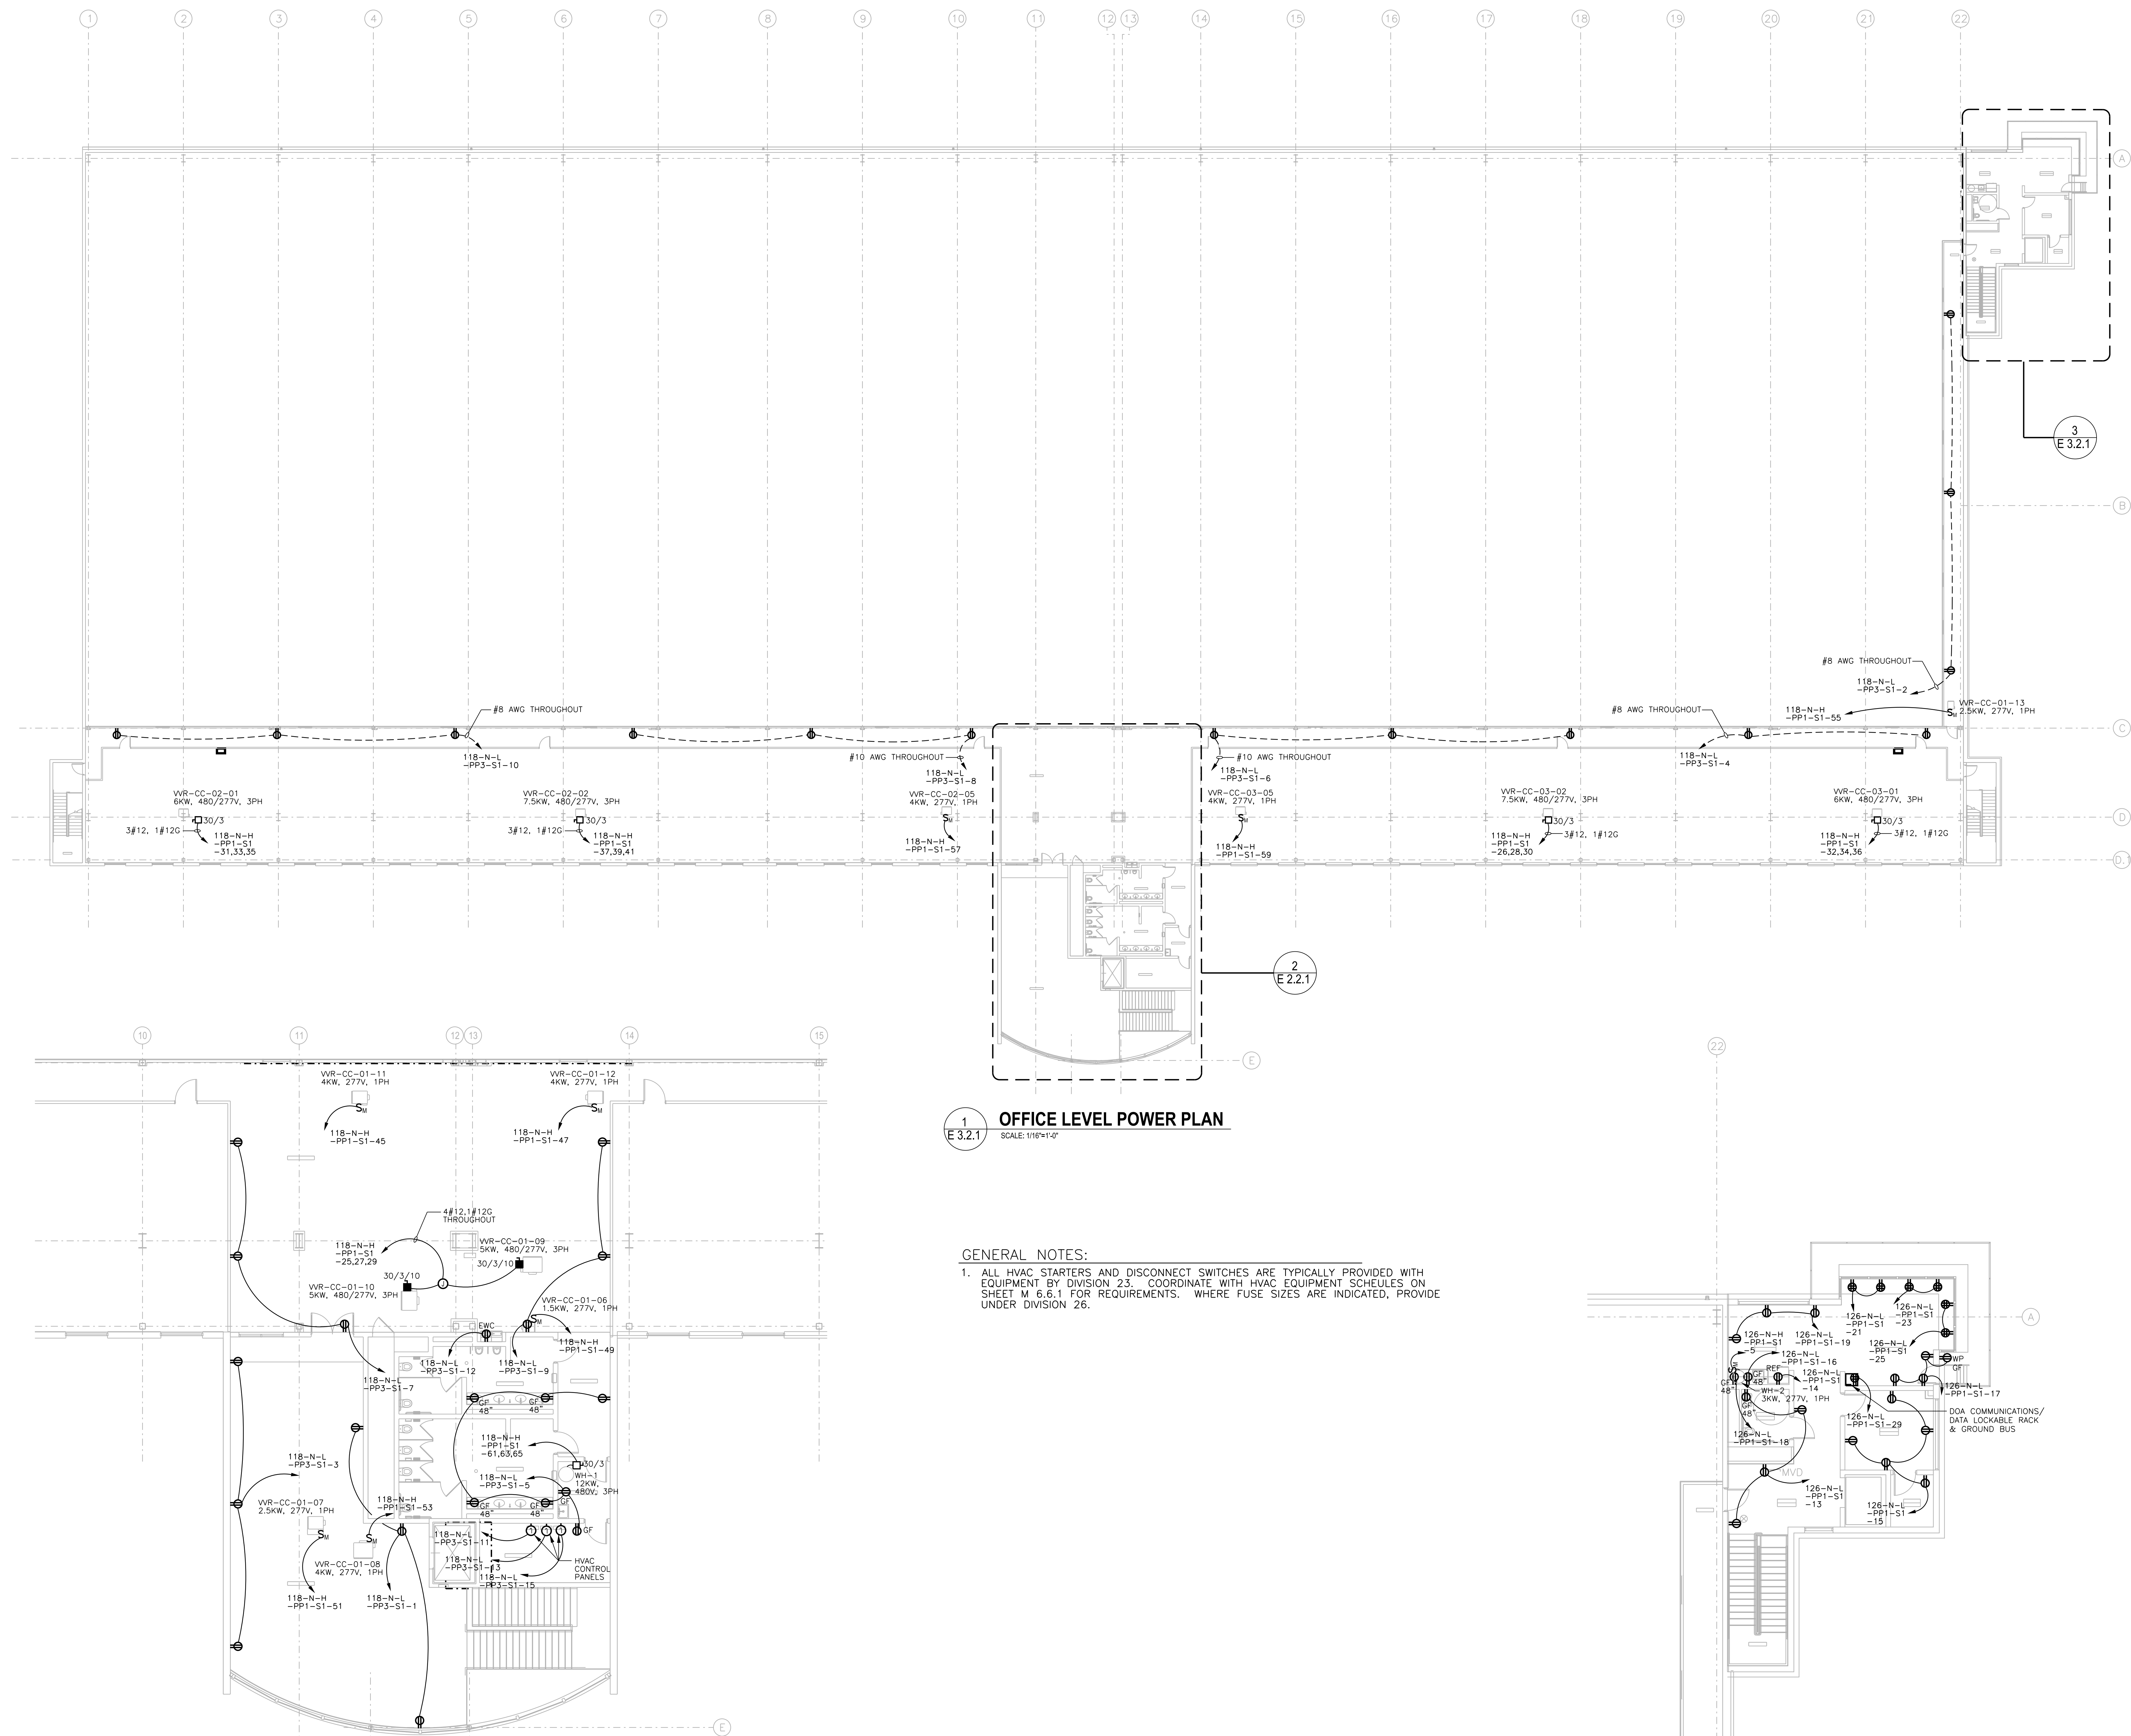

### 1 OFFICE LEVEL POWER PLAN

E 3.2.1 SCALE: 1/8"=1'-0"

#### GENERAL NOTES:

1. ALL HVAC STARTERS AND DISCONNECT SWITCHES ARE TYPICALLY PROVIDED WITH EQUIPMENT BY DIVISION 23. COORDINATE WITH HVAC EQUIPMENT SCHEDULES ON SHEET M 6.6.1 FOR REQUIREMENTS. WHERE FUSE SIZES ARE INDICATED, PROVIDE UNDER DIVISION 26.

### 2 PART PLAN - OFFICE LEVEL OFFICE POWER

E 3.2.1 SCALE: 1/8"=1'-0"

### 3 PART PLAN - OFFICE LEVEL DOA RAMP OPS POWER

E 3.2.1 SCALE: 1/8"=1'-0"





Hartsfield-Jackson  
Atlanta International Airport



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MARIETTA, GA 30066  
PHONE: 770.321.3936  
FAX: 770.321.3935



1  
F 3.3.1

GENERAL NOTES:


1. ALL HVAC STARTERS AND DISCONNECT SWITCHES ARE TYPICALLY PROVIDED WITH EQUIPMENT BY DIVISION 23. COORDINATE WITH HVAC EQUIPMENT SCHEDULES ON SHEET M 6.6.1 FOR REQUIREMENTS. WHERE FUSE SIZES ARE INDICATED, PROVIDE UNDER DIVISION 26.

KEYED NOTES:

- 1 FOR FANS REF-CC-03 & 09 ONLY, ROUTE POWER CIRCUIT HOMERUNS THROUGH VFD LOCATED ABOVE CEILING OF OFFICE LEVEL CORRIDOR, AND TIE CIRCUIT TO NON-VFD FAN ON LINE SIDE OF VFD. SEE MECHANICAL PLAN M 2.2.1 FOR VFD LOCATIONS.



2  
F 3.3.1

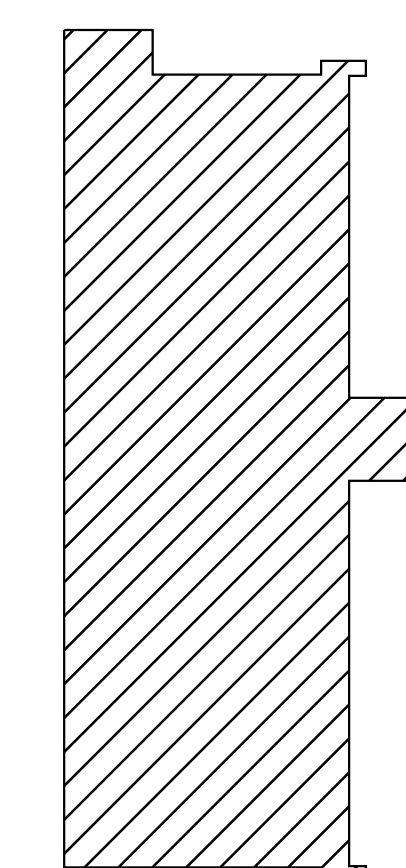

KEY MAP

NORTH

[illegible]

AIR CARGO BUILDING C

ELECTRICAL  
ROOF LEVEL  
POWER PLAN


ISS NUMBER: D.07.55.009	DRAWN BY: M. TRINKER
FC NUMBER: FC-6006007929-A	DESIGNED BY: M. TRINKER
A/E PROJECT NUMBER: HII-0730621	CHECKED BY: S. SVEDA
	APPROVED BY:
	DATE: 11/25/2014
	SCALE: AS NOTED
	SHEET NO. <b>E 3.3.1</b>

SE

FAIR CARGO BUILDING C. 100% CONSTRUCTION DOCUMENTS ISSUED FOR BID. NOVEMBER 25, 2014

NOT RELEASED FOR CONSTRUCTION



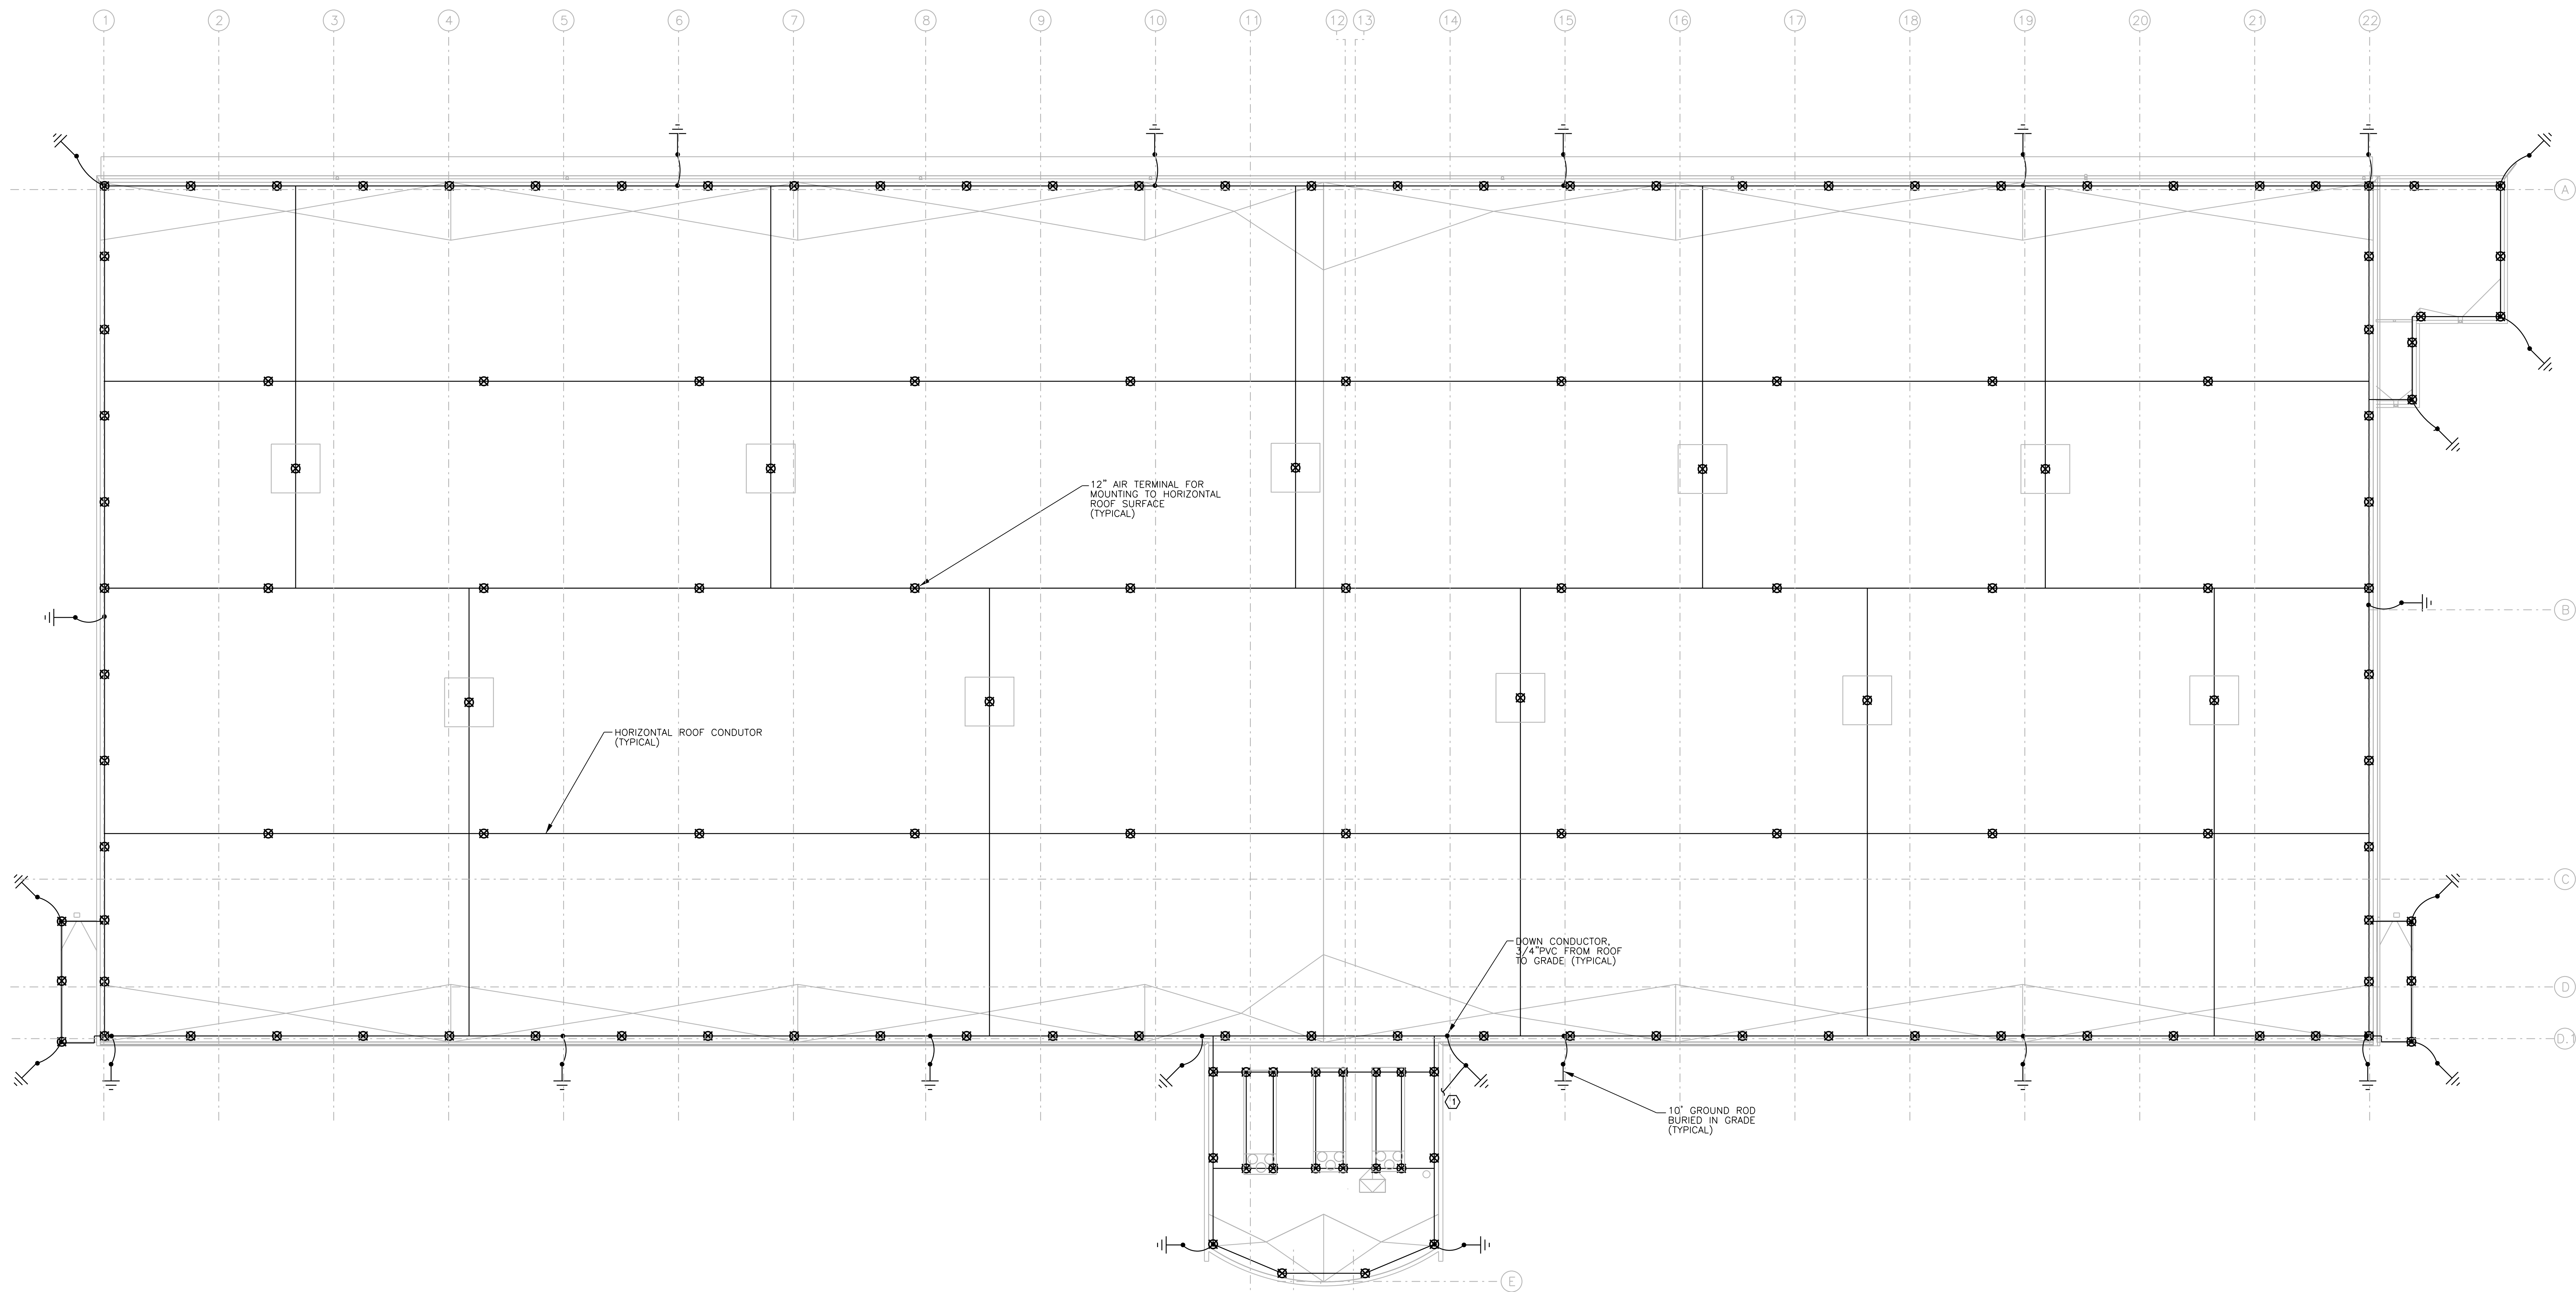

1  
E 3.3.2

**ROOF LEVEL LIGHTNING PROTECTION PLAN**  
SCALE: 1/16"=1'-0"

- GENERAL NOTES:**
- PLAN SHOWN HEREIN INDICATES A PERFORMANCE DESIGN FOR THE LIGHTNING PROTECTION SYSTEM BASED UPON THE INSTALLATION OF A CLASS 1 COPPER SYSTEM, COMPLETE WITH UL MASTER LABEL C CERTIFICATION. ALUMINUM COMPONENTS SHALL BE LIMITED TO WHERE ALUMINUM IS UTILIZED ON A SPECIFIC ROOF COMPONENT.
  - LIGHTNING PROTECTION VENDOR SHALL BE RESPONSIBLE FOR SIZING AND ROUTING OF ALL ROOF CABLES AND DOWNLEADS, ALONG WITH COORDINATING AIR TERMINAL LOCATIONS REQUIRED WITH ALL ROOF APPURTENANCES WHICH MAY DIFFER FROM WHAT IS SHOWN ON THIS PLAN.
  - THE LIGHTNING PROTECTION SYSTEM SHALL INCLUDE BUT NOT BE LIMITED TO THE FOLLOWING COMPONENTS:  
  
COPPER AIR TERMINALS EXTENDING 12" ABOVE ROOF SURFACES OR PARAPHETS.  
COPPER ROOF AND DOWN CONDUCTORS (WHERE ALUMINUM MAY BE REQUIRED, PROVIDE BI-METALLIC CONNECTORS TO TRANSITION TO COPPER).  
AIR TERMINAL AND CABLE SUPPORTS, COORDINATED WITH ROOF MATERIAL AND SYSTEM.  
10'-0" LONG GROUND RODS, BURIED 2'-6" MINIMUM TO TOP.

**KEYED NOTES:**  
(1) TIE TO SERVICE ENTRANCE GROUND SYSTEM AT MAIN SWITCHBOARD.



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Atlanta International Airport





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PHONE: 770.321.9308  
FAX: 770.321.3935



KEY MAP

NO. DATE BY REVISION

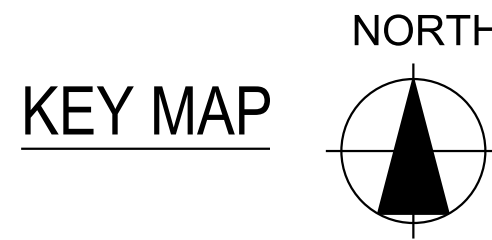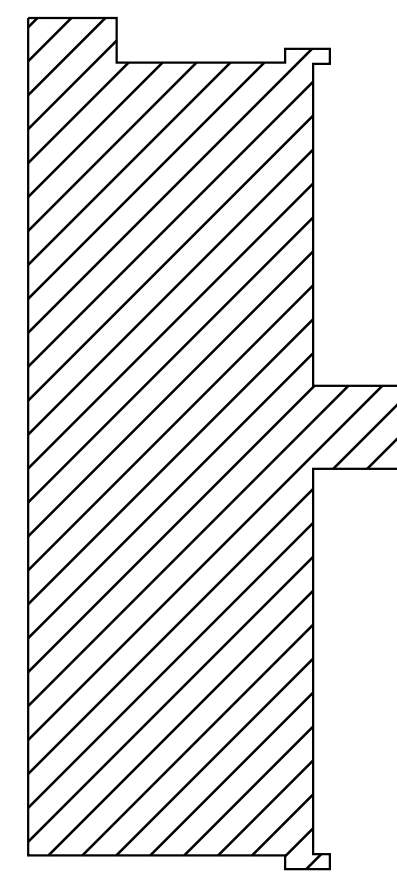AIR CARGO BUILDING C

**ELECTRICAL  
ROOF LEVEL  
LIGHTNING PROTECTION PLAN**

WBS NUMBER:  
D.07.55.009  
FC NUMBER:  
FC-6006007529-A  
A/E PROJECT NUMBER:  
HII-0730621

DRAWN BY:  
M. TRINKER  
DESIGNED BY:  
M. TRINKER  
CHECKED BY:  
S. SVEDA  
APPROVED BY:  
S. SVEDA


DATE:  
11/25/2014

SCALE:  
1/4"=1'-0"

SHEET NO:

**E 3.3.2**

NORTH

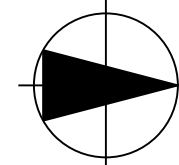

SEAL





CITY OF ATLANTA, GEORGIA

Hartsfield-Jackson  
Atlanta International Airport

**HSST**


HEERY INTERNATIONAL, INC. 999  
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AIR CARGO BUILDING C, 100% CONSTRUCTION DOCUMENTS ISSUED FOR BID, NOVEMBER 25, 2014



KEY MAP  
NORTH

NO. DATE BY REVISION

AIR CARGO BUILDING C

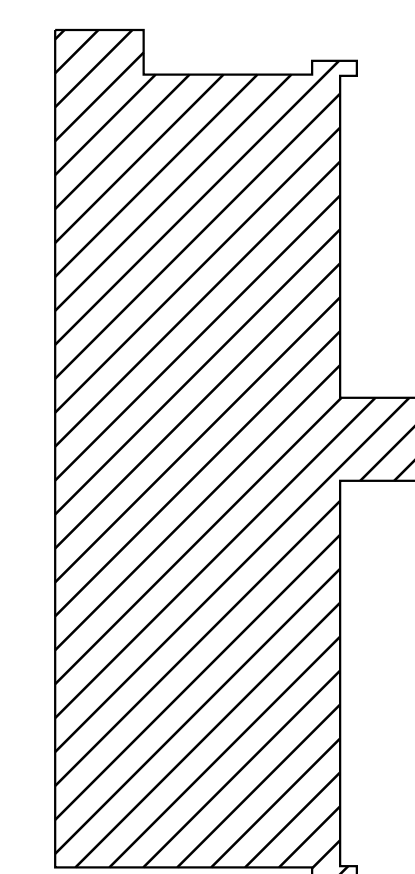ELECTRICAL  
OPERATIONS LEVEL  
SYSTEMS PLAN

WBS NUMBER:  
D.07.55.009

FC NUMBER:  
FC-6006007929-A

A/E PROJECT NUMBER:  
HII-0730621

DRAWN BY:  
M. TRINKER

DESIGNED BY:  
M. TRINKER

CHECKED BY:  
S. SVEDA

APPROVED BY:  
S. SVEDA

DATE:  
11/25/2014


SCALE:  
AS NOTED

SHEET NO.:

E 4.1.1

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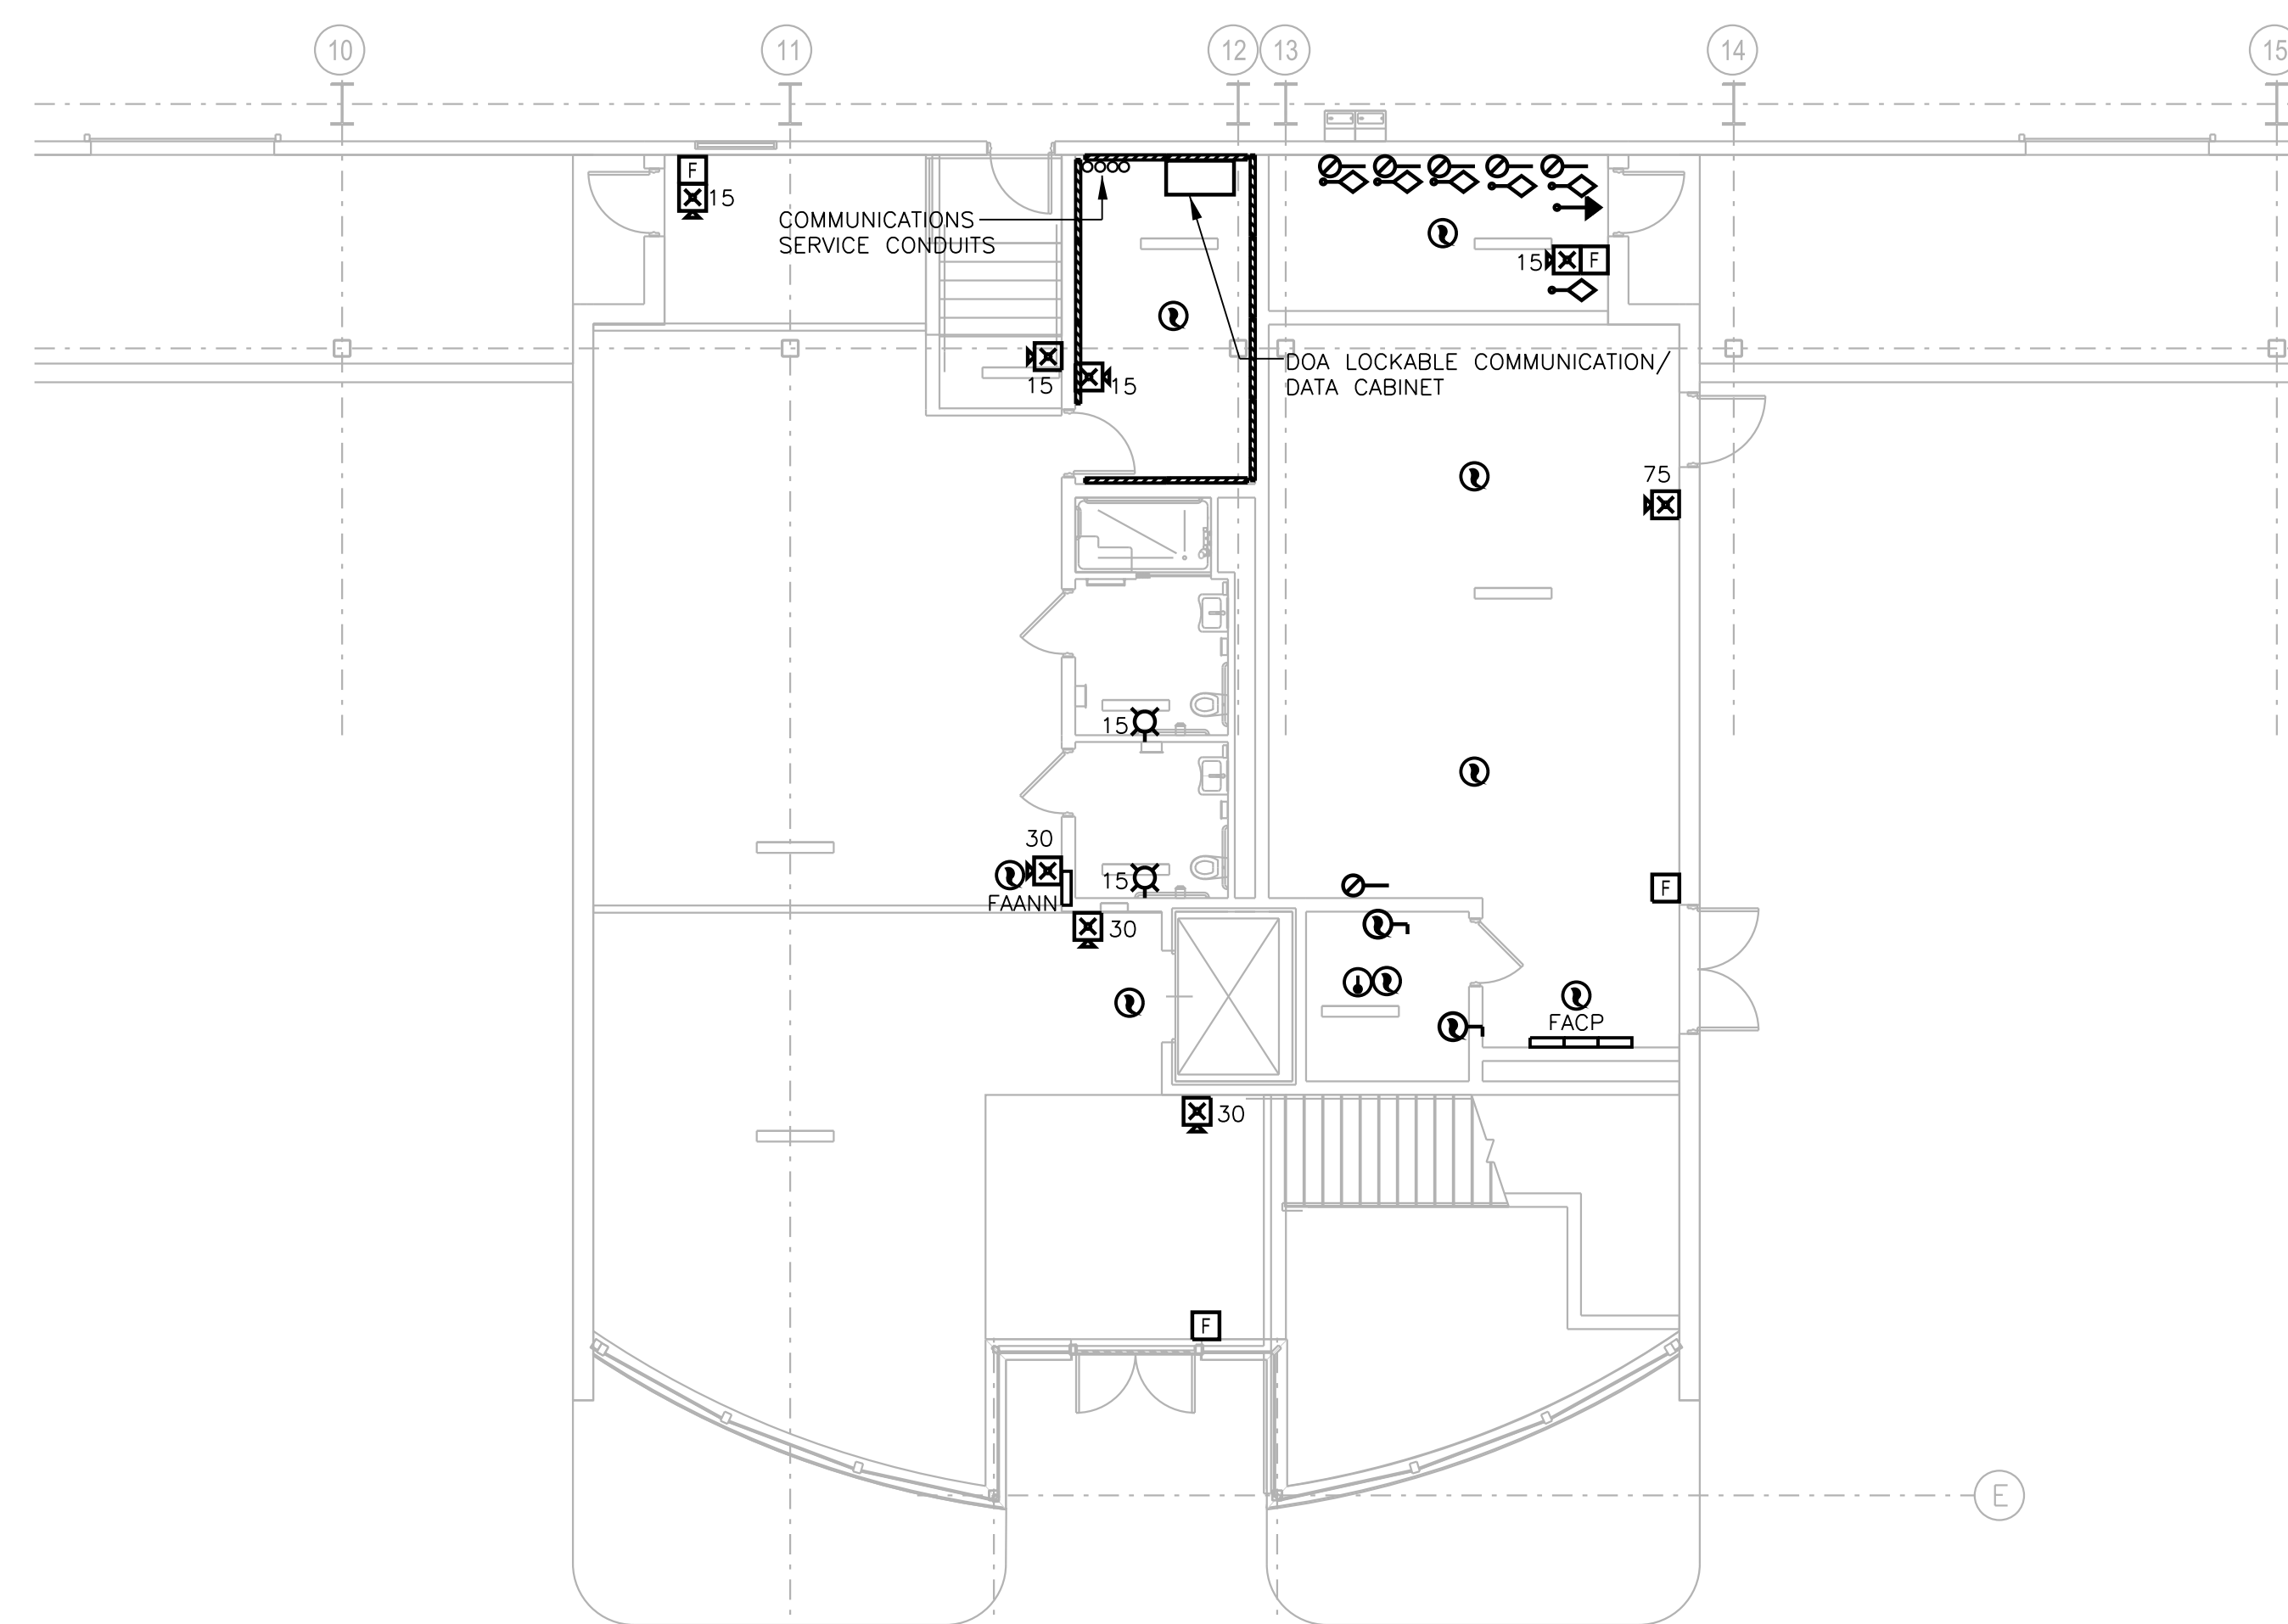
1 OPERATIONS LEVEL SYSTEMS PLAN  
SCALE: 1/16"=1'-0"

GENERAL NOTES:

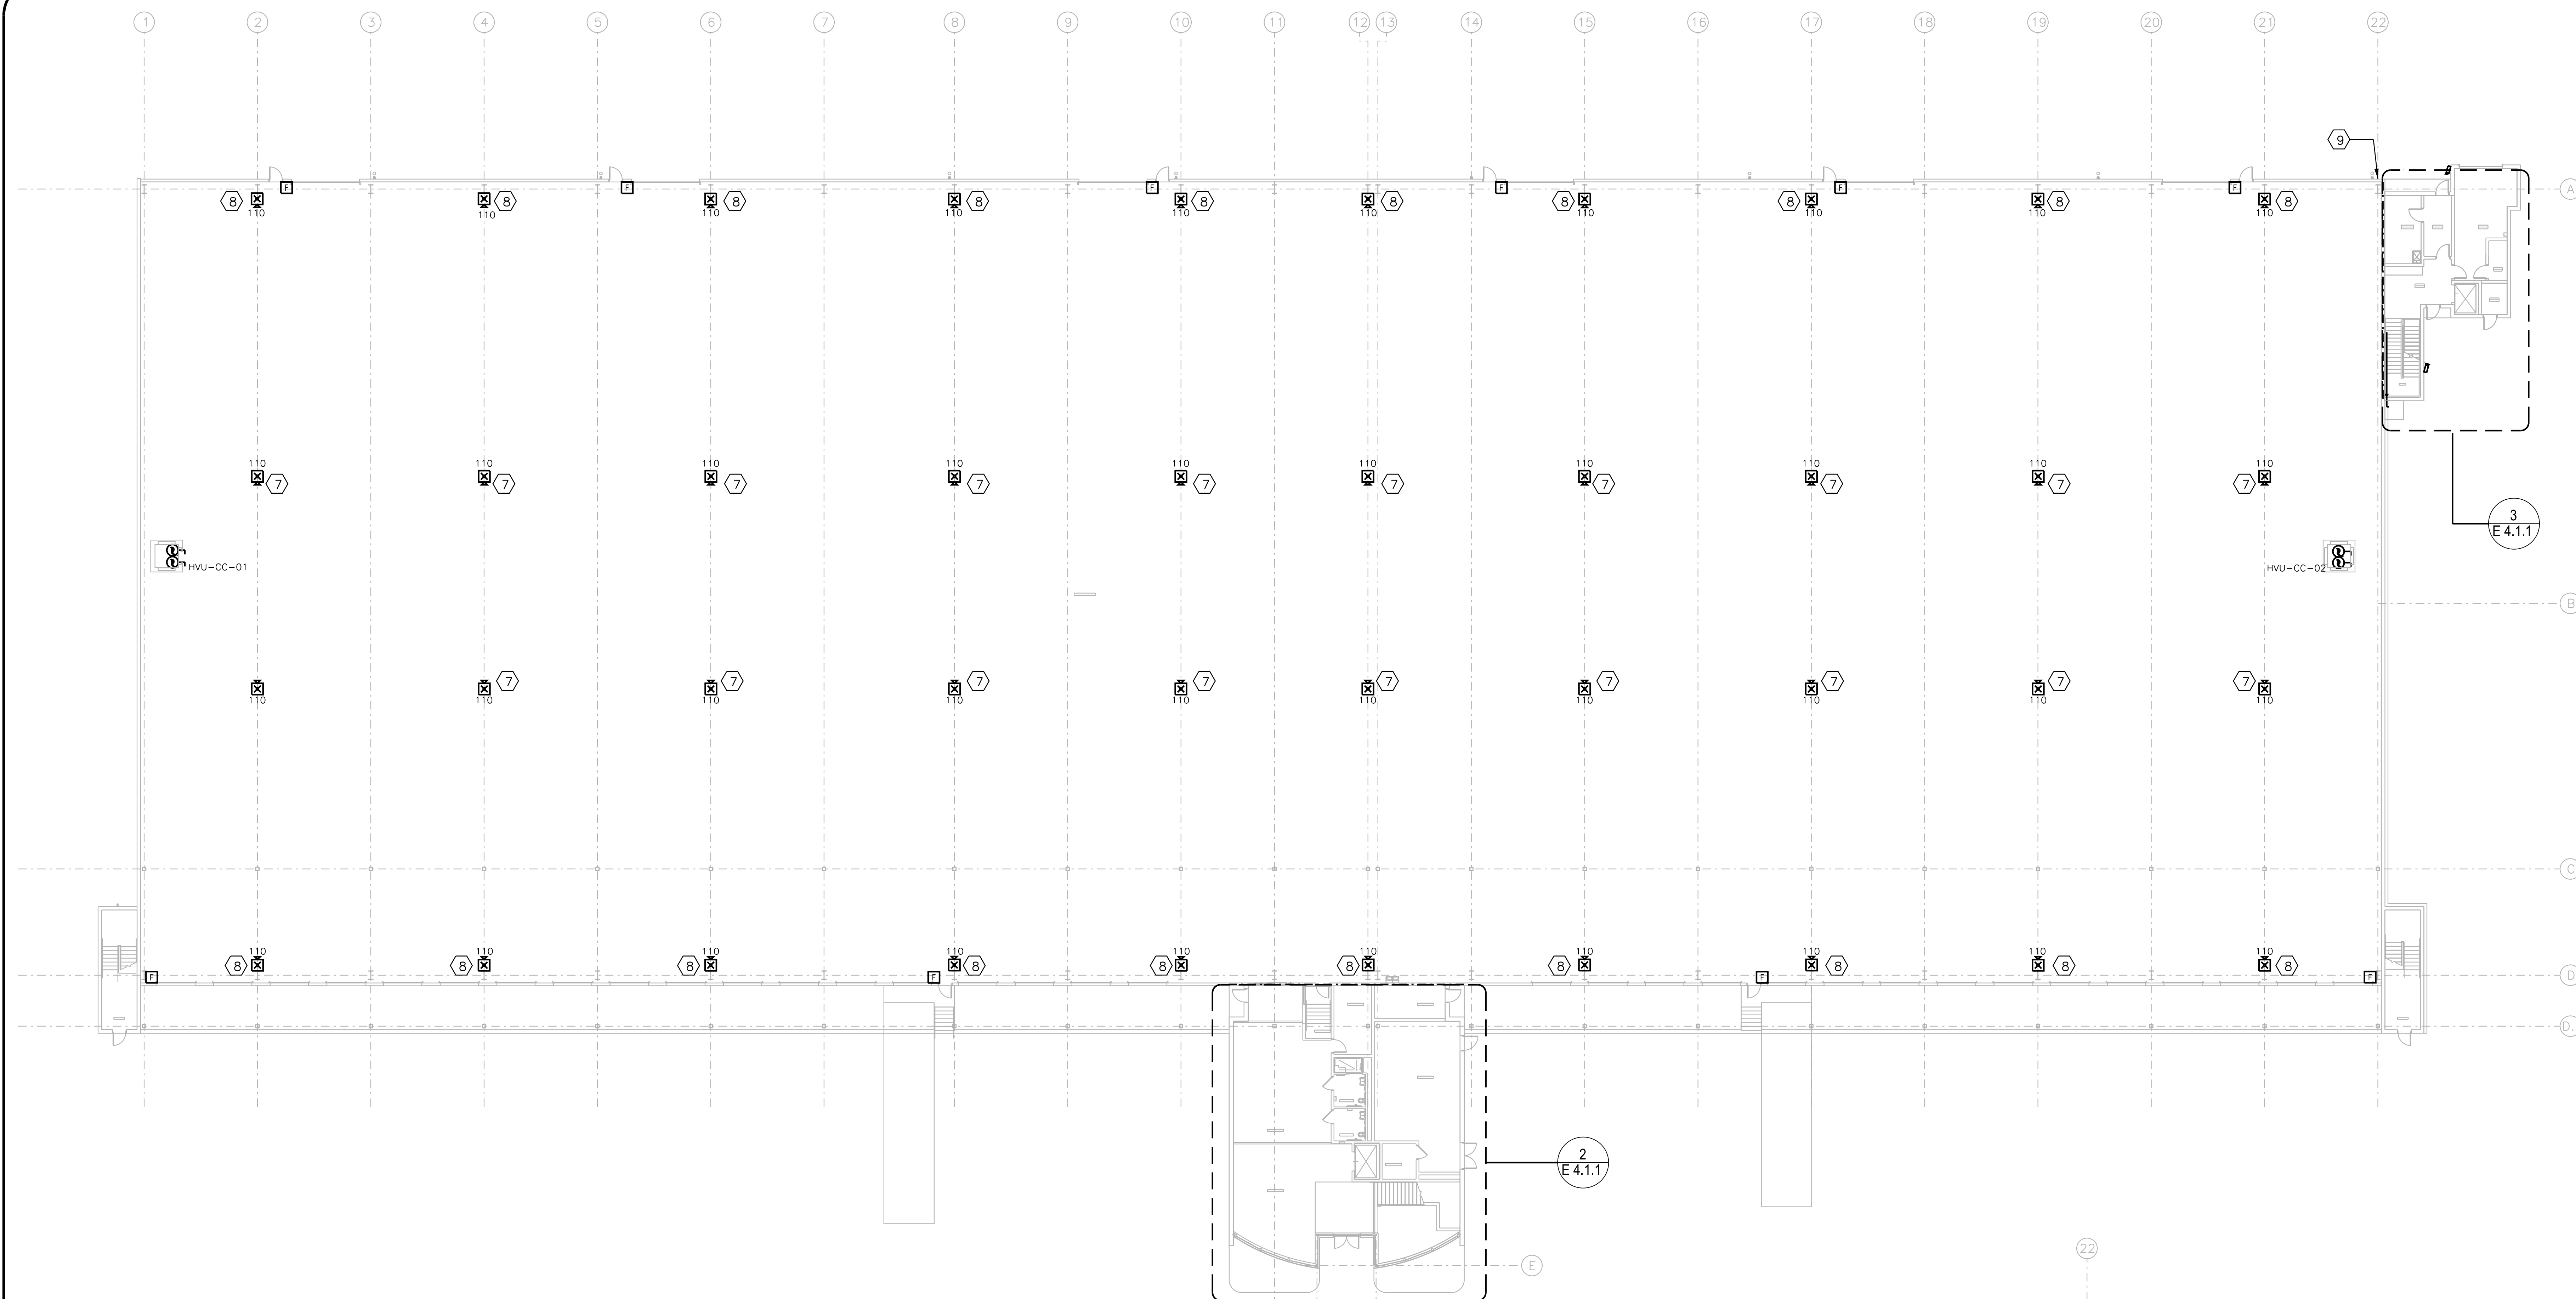
- COORDINATE ALL SECURITY SYSTEM REQUIREMENTS WITH DOA SECURITY AND THE AIRPORT'S VENDOR MC DEAN, AS INDICATED IN GENERAL NOTE 21, SHEET E 0.1.1.
- COORDINATE ALL COMMUNICATIONS/DATA SYSTEM REQUIREMENTS WITH DOA IT, AS INDICATED IN GENERAL NOTE 22, SHEET E 0.1.1.

KEYED NOTES:

- SACS PANEL SHALL CONSIST OF A LENEL 3000 FIELD PANEL, WITH ASSOCIATED NETWORK EQUIPMENT, POWER SUPPLIES, RACK AND RACK TYPE UPS. PROVIDE A FIBER OPTIC CABLE CONNECTION IN 1" TO DATA EQUIPMENT IN DOA IT LOCKABLE RACK IN DOA OPERATIONS ROOM 225 ABOVE.
- CCTV HEAD END EQUIPMENT MOUNTED TO WALL WITH FIBER OPTIC CABLES CONNECTION IN 1" TO DATA EQUIPMENT IN DOA IT LOCKABLE RACK IN OPERATIONS ROOM 225 ABOVE.
- FIXED CAMERA MOUNTED TO WALL IN WEATHERPROOF ENCLOSURE, MOUNTED 10'-0" AFF.
- EXIT DOOR WITH CARD READERS BOTH SIDES. SEE CARD READER HARDWARE DOOR DETAIL HW29C, 8/E 9.1.1 FOR CONNECTION REQUIREMENTS.
- EXIT DOOR WITH CARD READER ON PUBLIC ENTRY SIDE, PANIC HARDWARE ON EXIT. SEE CARD READER HARDWARE DOOR DETAIL HW29B, 9/E 9.1.1 FOR CONNECTION REQUIREMENTS.
- EXIT DOOR WITH CARD READER AND KEY SWITCH ON ENTRY SIDE, PUSHBUTTON TO EXIT. SEE CARD READER HARDWARE DOOR DETAIL HW87, 10/E 9.1.1 FOR CONNECTION REQUIREMENTS.
- MOUNT DEVICE TO UNDERSIDE OF TRUSS, 28'-0" AFF.
- MOUNT DEVICE TO WALL OR COLUMN AS INDICATED, 80" AFF TO BOTTOM
- LOCATION OF MESH AP POLE, MOUNTED TO BUILDING AT ROOF LEVEL. SEE COMMUNICATIONS RISER DIAGRAM 1/E 7.1.2 FOR COMPONENT REQUIREMENTS AND MOUNTING DETAILS.



2 PART PLAN - OPERATIONS LEVEL OFFICE SYSTEMS  
SCALE: 1/8"=1'-0"

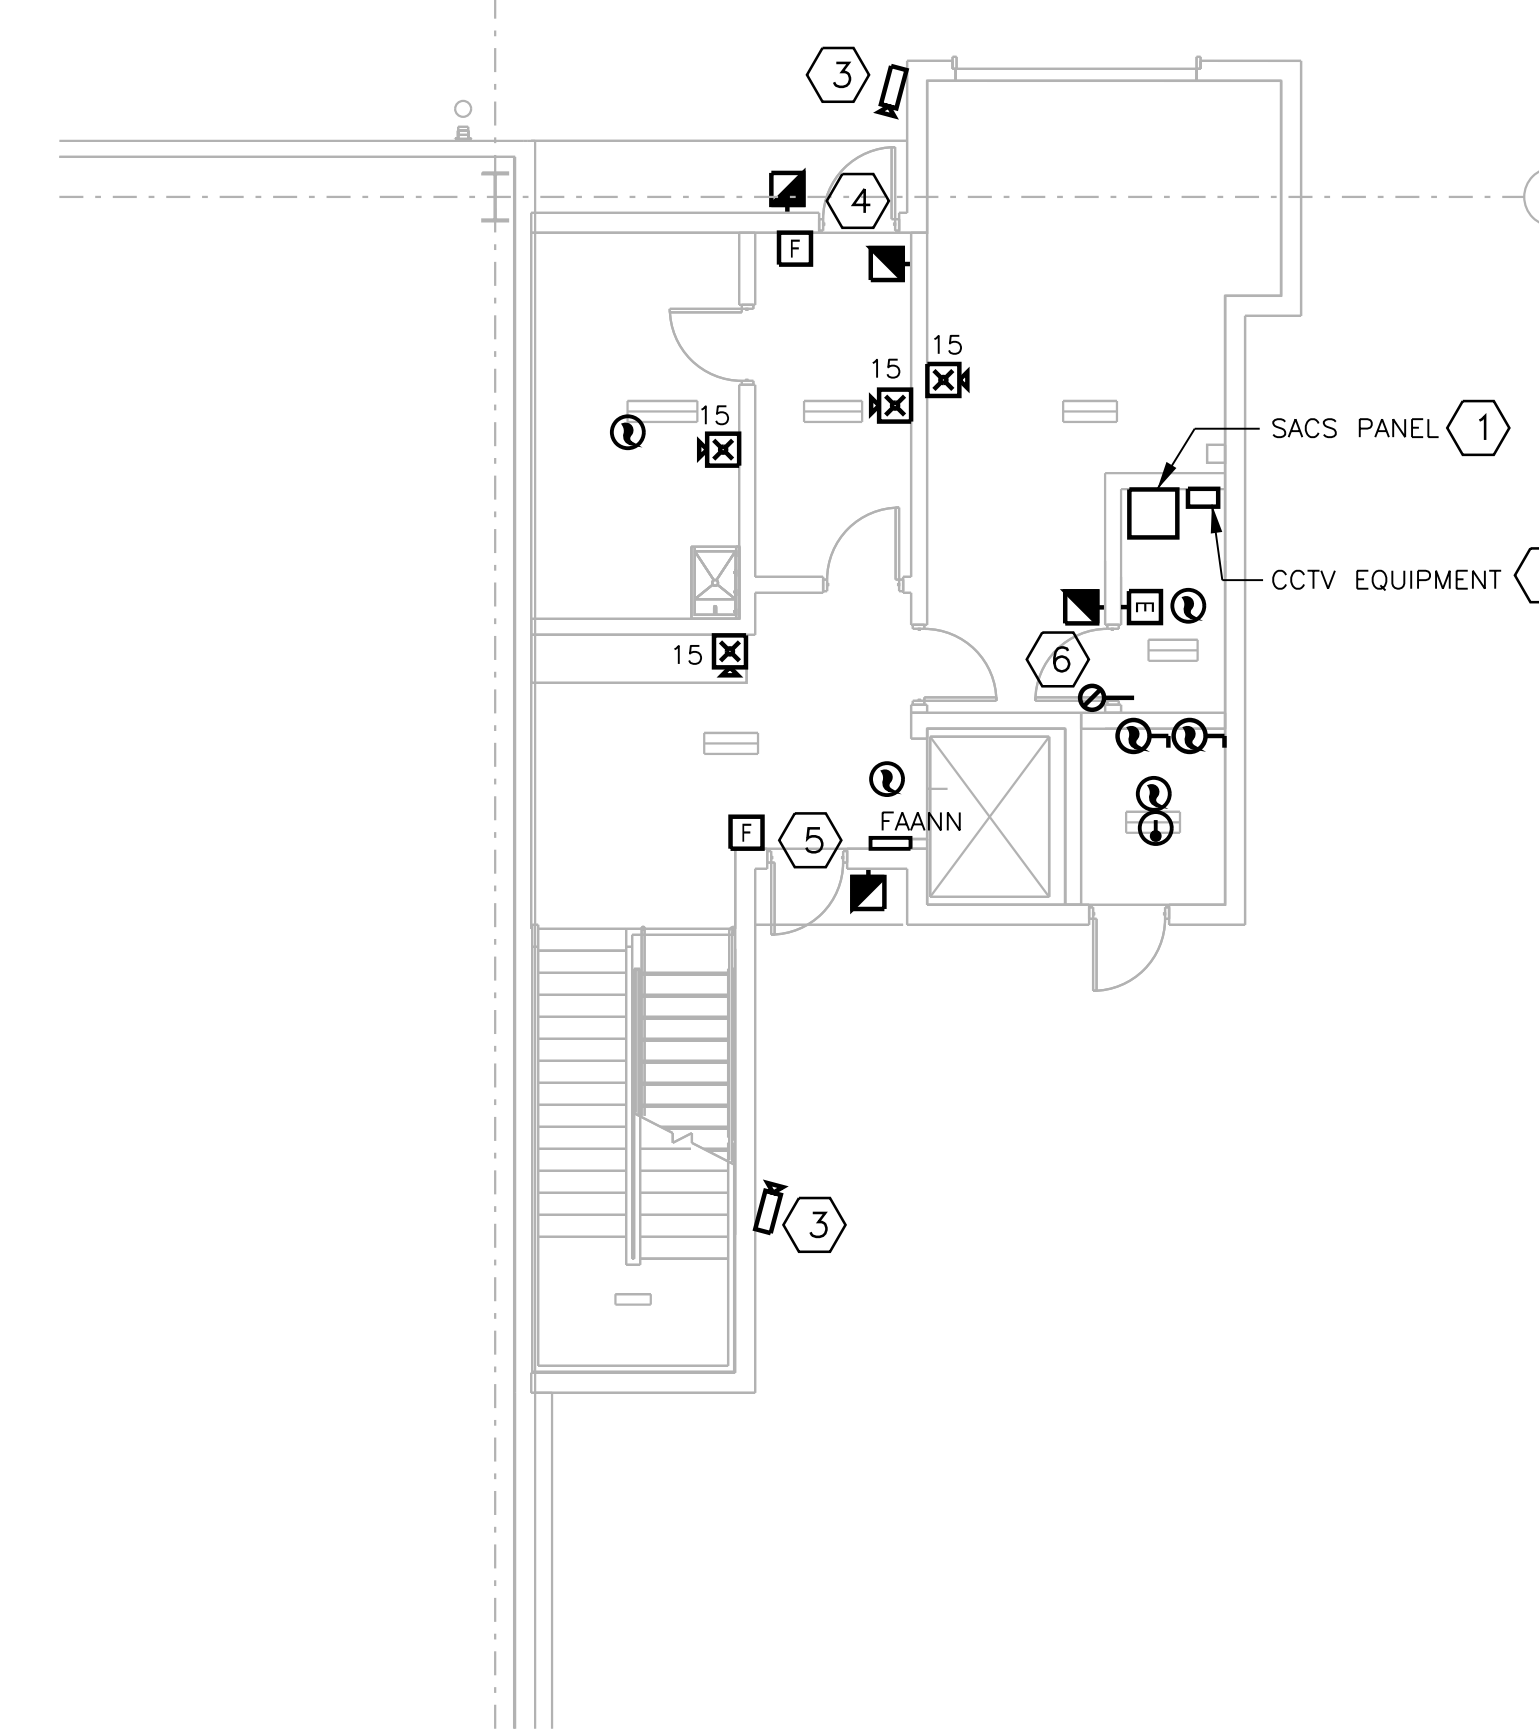

3 PART PLAN - OPERATIONS LEVEL DOA RAMP OPS SYSTEMS  
SCALE: 1/8"=1'-0"



CITY OF ATLANTA, GEORGIA

Hartsfield-Jackson  
Atlanta International Airport




HEERY INTERNATIONAL, INC. 999  
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AIR CARGO BUILDING C, 100% CONSTRUCTION DOCUMENTS ISSUED FOR BID, NOVEMBER 25, 2014



NO. DATE BY REVISION

AIR CARGO BUILDING C

ELECTRICAL  
OFFICE LEVEL  
SYSTEMS PLAN

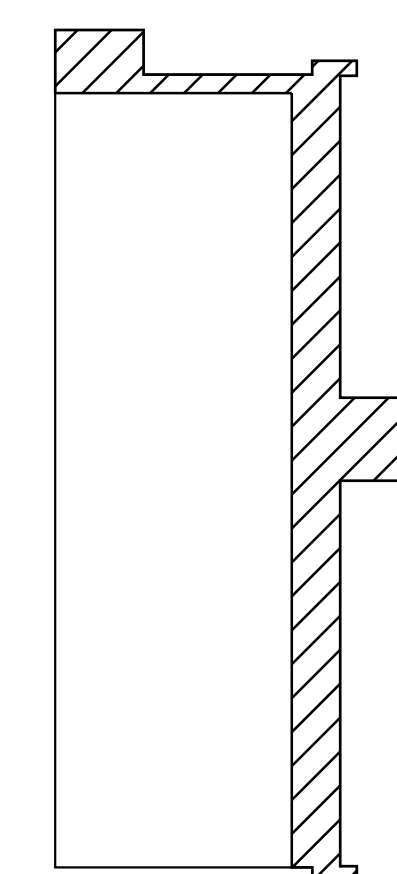WBS NUMBER:  
D.07.55.009  
FC NUMBER:  
FC-6006007529-A  
A/E PROJECT NUMBER:  
HII-0730621

DRAWN BY:  
M. TRINKER  
DESIGNED BY:  
M. TRINKER  
CHECKED BY:  
S. SVEDA  
APPROVED BY:  
S. SVEDA

DATE:  
11/25/2014


SCALE:  
AS NOTED

SHEET NO.:

E 4.2.1

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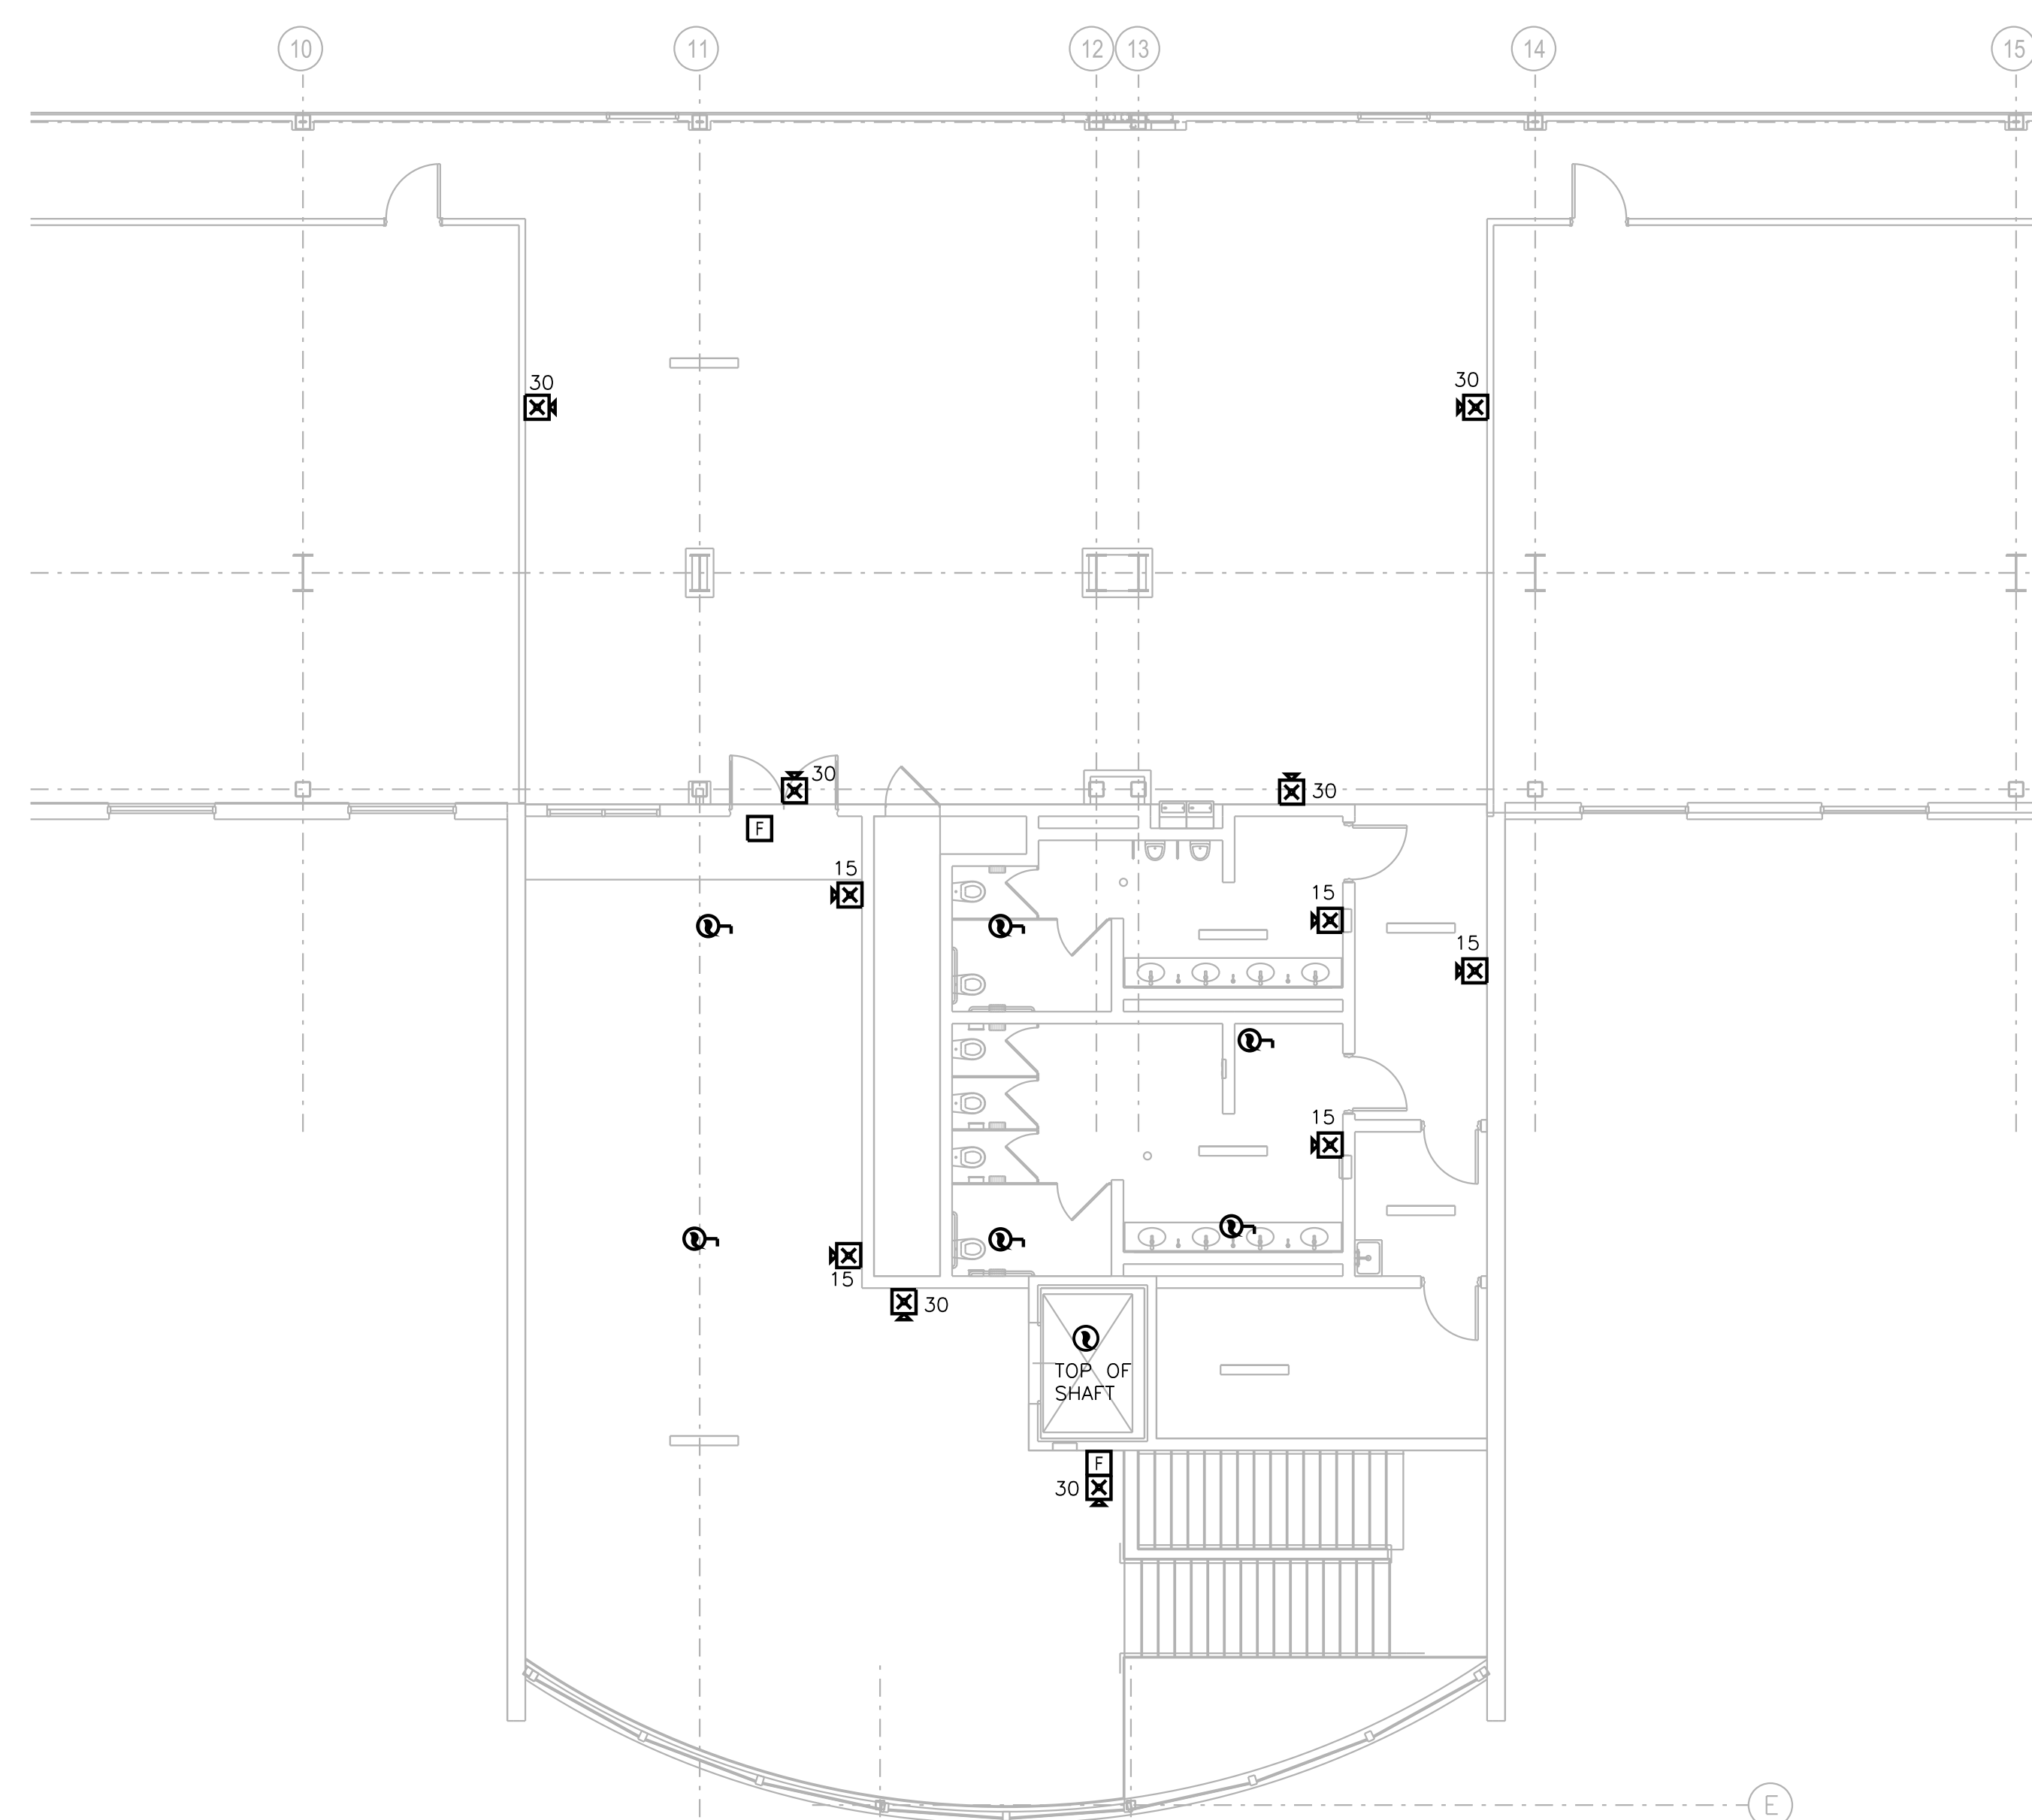
1 OFFICE LEVEL SYSTEMS PLAN  
SCALE: 1/16"=1'-0"

GENERAL NOTES:

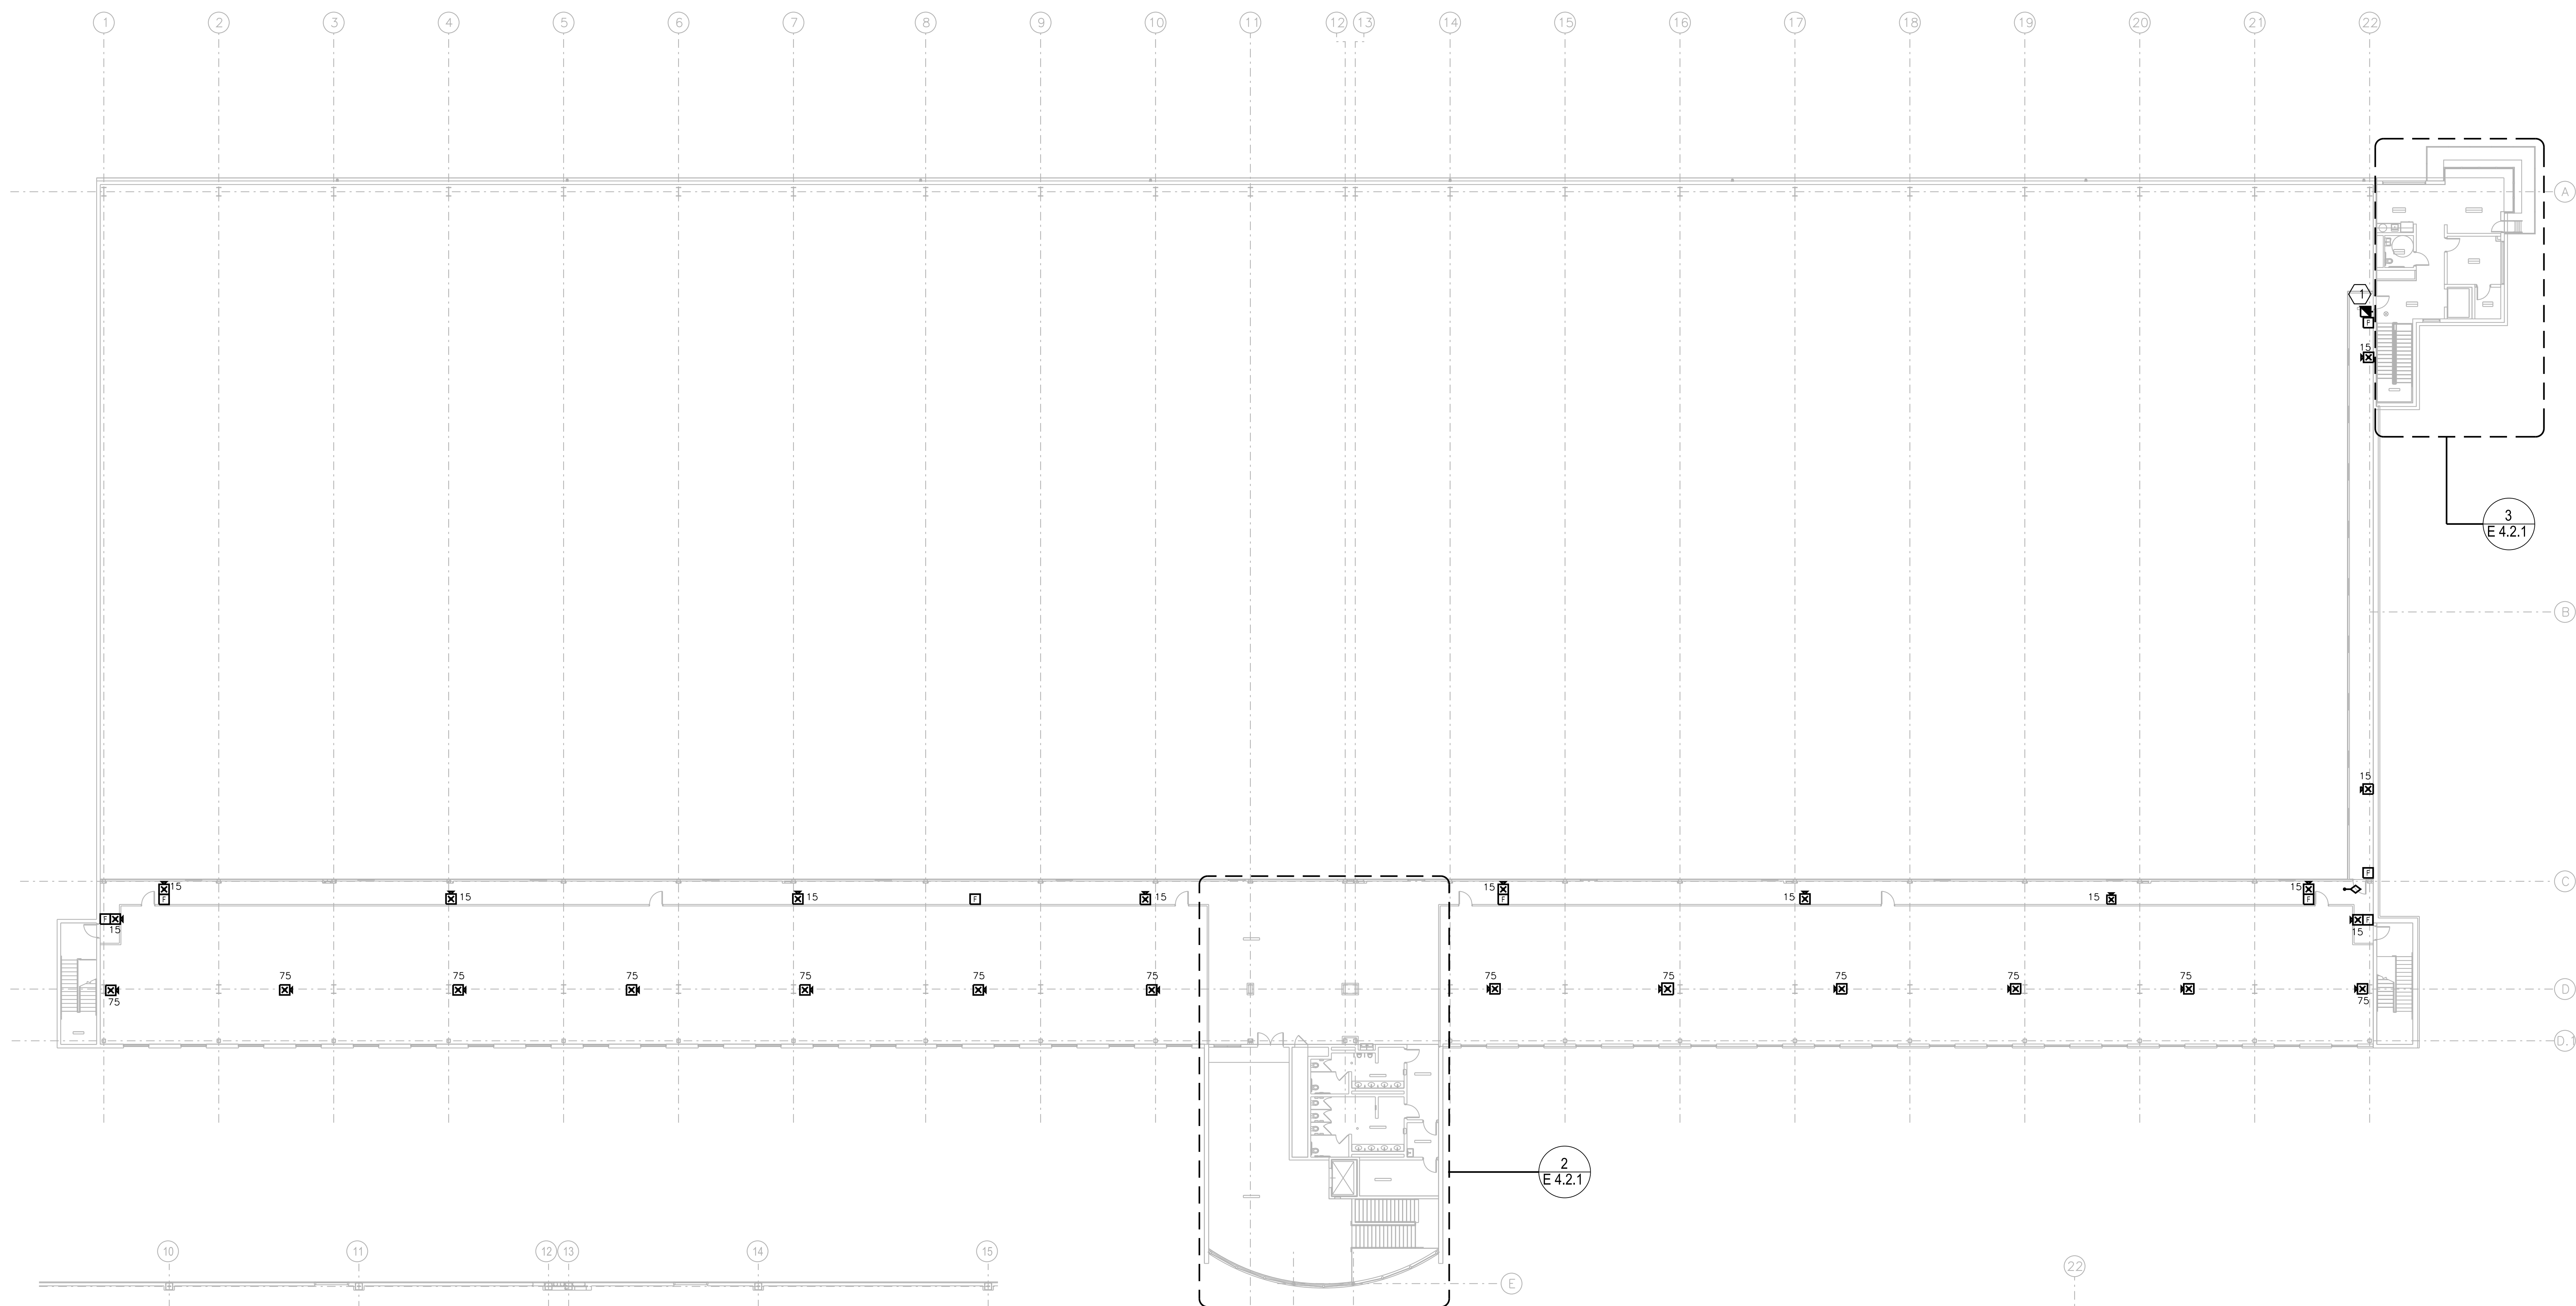
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- COORDINATE ALL COMMUNICATIONS/DATA SYSTEM REQUIREMENTS WITH DOA IT, AS INDICATED IN GENERAL NOTE 22, SHEET E 0.1.1.

KEYED NOTES:

- 1 EXIT DOOR WITH CARD READERS BOTH SIDES. SEE CARD READER HARDWARE DOOR DETAIL HW29C, 8/E 9.1.1 FOR CONNECTION REQUIREMENTS.



2 PART PLAN - OFFICE LEVEL OFFICE SYSTEMS  
SCALE: 1/8"=1'-0"

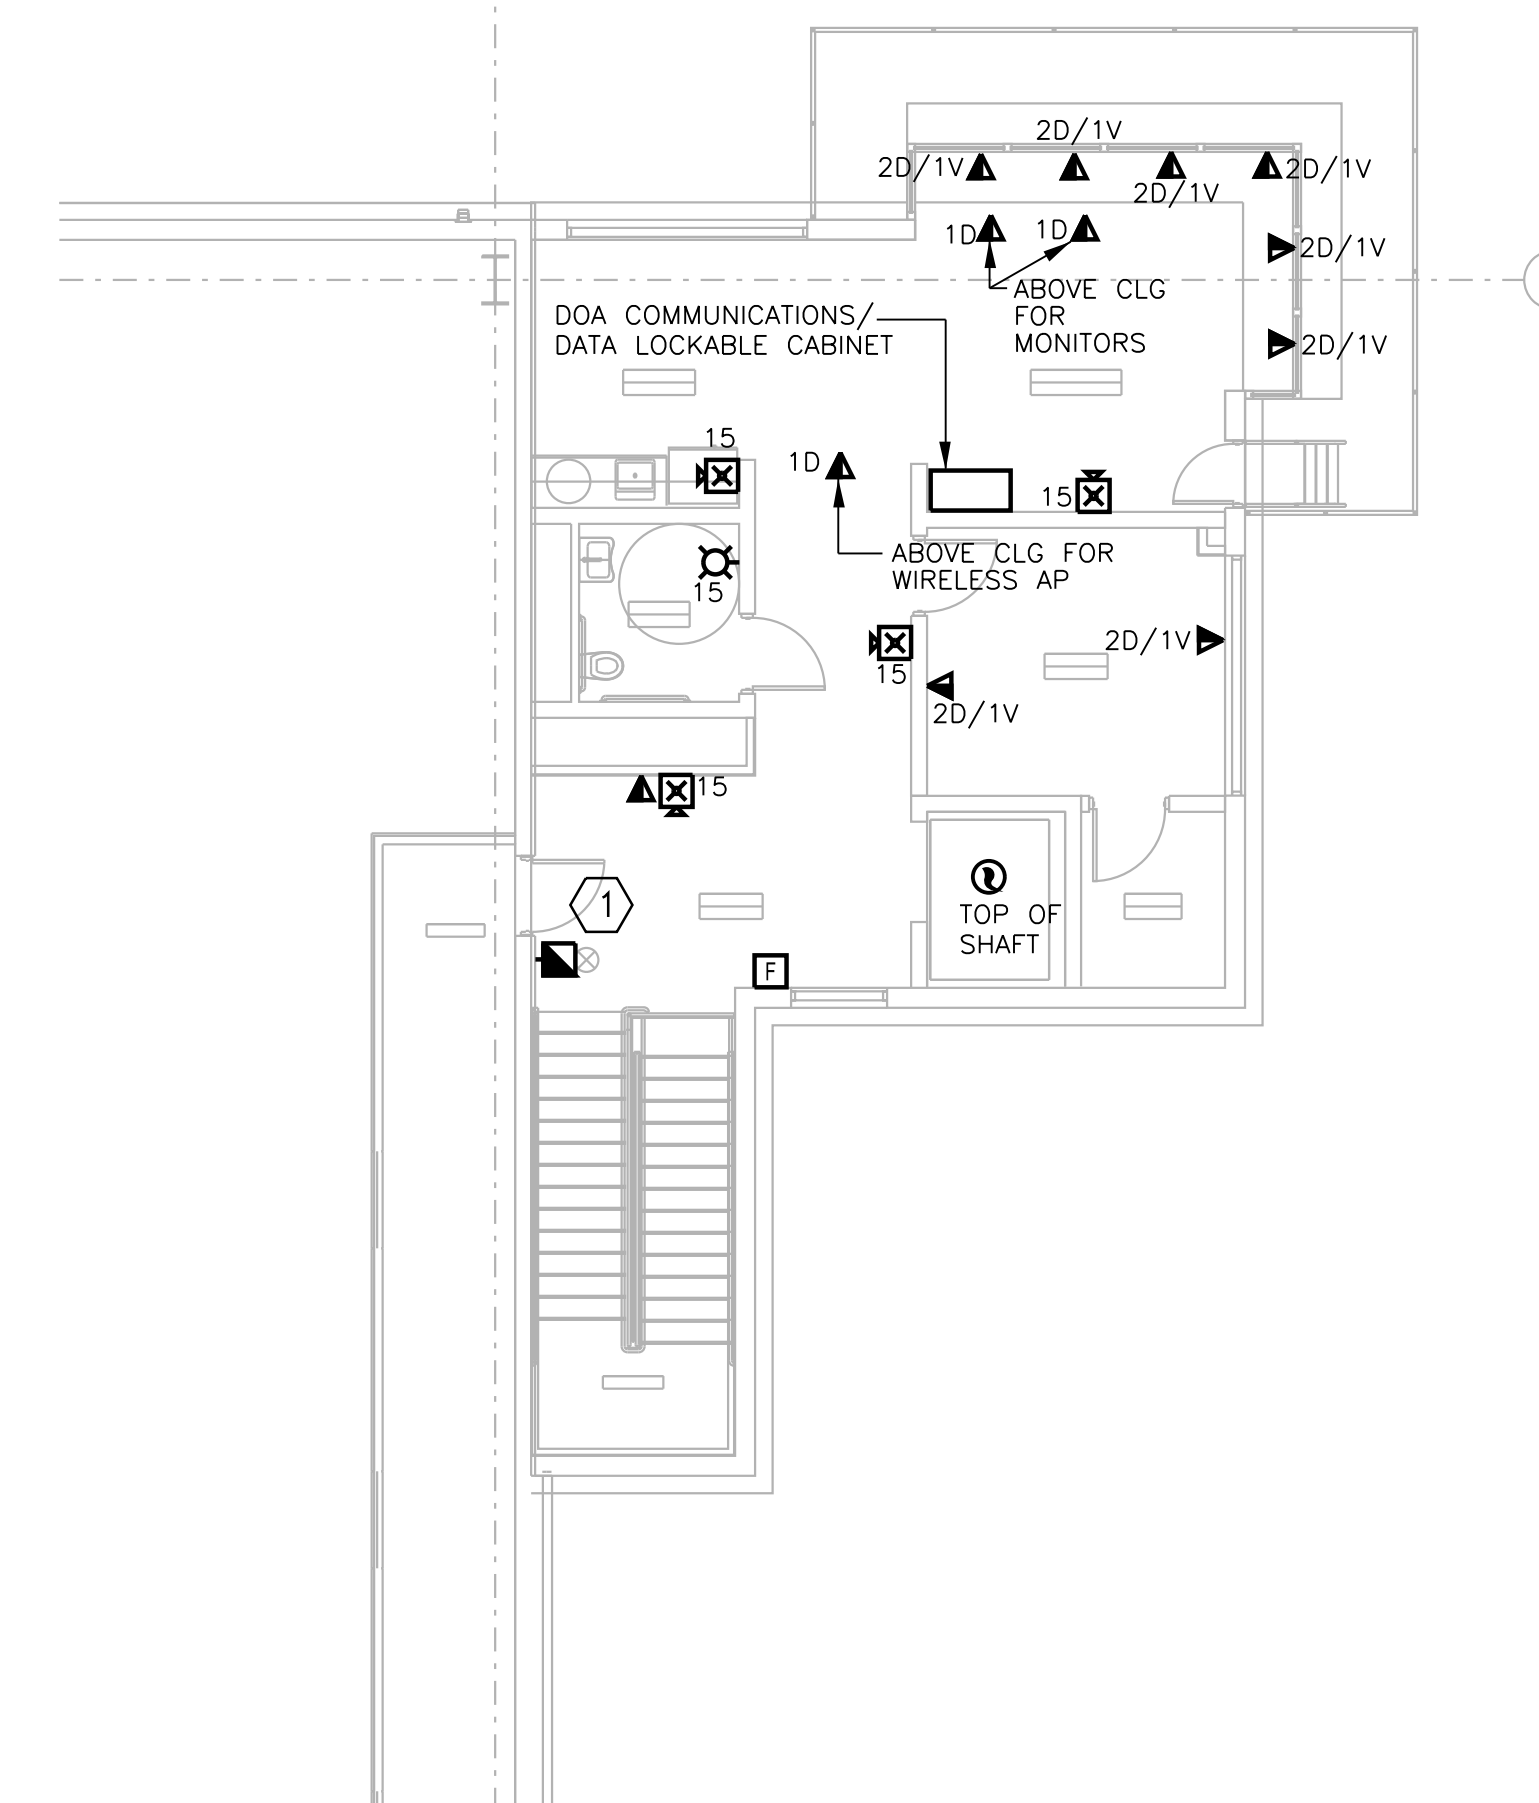

3 PART PLAN - OFFICE LEVEL DOA RAMP OPS SYSTEMS  
SCALE: 1/8"=1'-0"



MAIN SWITCHBOARD				118-N-H-SB1-UT-S1/S2		SUMMARY SCHEDULE						
		VOLTAGE:	480Y/277V	PHASE:	3	WIRES:	4	AMPERES INTERRUPTING RATING:		50,000		
NO.	SERVING			CONN.	BREAKER		REMARKS					
				KVA	FRAME	TRIP					POLES	
1	SWBD 118-N-H-SB1-UT-S1 MAIN BREAKER			706.25	2000	2000	3	BUILDING LOADS				
2	SWBD 118-N-H-SB1-UT-S2 MAIN BREAKER			7.72	250	225	3	ROADWAY / PARKING LOT LOADS				
TOTAL CONNECTED KVA:					713.97		TOTAL DEMAND OR DESIGN KVA:					1002.57
DEMAND OR DESIGN KVA:					657.57		DEMAND OR DESIGN AMPERES:					1205.91
FUTURE KVA:					345.00							

MAIN SWITCHBOARD						118-NH-SB1-UT-S1		SCHEDULE	
MAINS: 2000/3 MCB		VOLTAGE: 480Y/277V		PHASE: 3		WIRES: 4		AMPERES INTERRUPTING RATING: 50,000	
NO.	SERVING	CONN. KVA	BREAKER			REMARKS			
			FRAME	TRIP	POLES				
1	PNLBD 118-N-H-PP1-S1	343.53	600	600	3	HVAC			
2	PNLBD 118-N-H-PP2-S1	73.18	225	225	3	INTERIOR LIGHTS			
3	PNLBD 118-N-H-PP3-S1	62.88	225	225	3	EXTERIOR LIGHTS			
4	XFMR 118-N-H-TR1-S1	27.78	225	175	3	DISTR. PANELBOARD 118-N-L-PP1-S1			
5	PNLBD 101-N-H-PP1-S1	65.55	225	225	3	WAREHOUSE			
6	PNLBD 101-N-H-PP2-S1	55.57	225	225	3	WAREHOUSE			
7	PNLBD 101-N-H-PP3-S1	7.58	225	225	3	WAREHOUSE			
8	PNLBD 101-N-H-PP4-S1	7.58	225	225	3	WAREHOUSE			
9	PNLBD 126-N-H-PP1-S1	62.80	225	225	3	METERED PANELBOARD SERVING DOA RAMP OPS			
10	SPACE								
11	SPACE								
12	SPACE								
13	SPACE								
14	SPACE								
		TOTAL CONNECTED KVA:		706.25		TOTAL DEMAND OR DESIGN KVA:		987.92	
		DEMAND OR DESIGN KVA:		647.92		DEMAND OR DESIGN AMPERES:		1188.28	
		FUTURE KVA:		340.00					

MAIN SWITCHBOARD						118-N-H-SB1-UT-S2		SCHEDULE								
MAINS:		225/3 MCB	VOLTAGE:		480Y/277V	PHASE:		3	WIRES:		4	AMPERES INTERRUPTING RATING:		50,000		
NO.	SERVING					CONN. KVA	BREAKER		FRAME		TRIP		POLES		REMARKS	
	PNLBD 118-N-H-PP1-S2					7.72	-		-		3		ROADWAY / PARKING LOT LIGHTS			

DISTRIBUTION PANELBOARD										118-N-L-PP1-S1			SCHEDULE								
MAINS:		400/3 MCB		VOLTAGE:		208Y/120V		PHASE:		3		WIRES:		4		AMPERES INTERRUPTING RATING:		10,000			
NO.	SERVING			CONN. KVA	BREAKER				REMARKS												
					FRAME	TRIP	POLES														
1	PNLBD 118-N-L-PP2-S1			14.00	225	225	3	OPERATIONS LEVEL POWER													
2	PNLBD 118-N-L-PP3-S1			13.78	225	225	3	OFFICE LEVEL POWER													
3	SPACE						3														
4	SPACE						3														
5	SPACE						3														
6	SPACE						3														
7	SPACE						3														
8	SPACE						3														
9	SPACE						3														
TOTAL CONNECTED KVA:										27.78		TOTAL DEMAND OR DESIGN KVA:								112.50	
DEMAND OR DESIGN KVA:										27.30		DEMAND OR DESIGN AMPERES:								312.27	
FUTURE KVA:										85.20											

PANELBOARD: 118-N-H-PP1-S1						LOCATION: ELEC ROOM 118							
TYPE: SERVICE: MAINS: CABINET:		LIGHTING & APPLIANCE 480Y/277V, 3PH, 4W 500 A MLO				<input type="checkbox"/> FEED-THRU LUGS <input type="checkbox"/> SUB-FEED LUGS		1. SUBMITTALS: CONTRACTOR SHALL NOT DEVIATE FROM CIRCUIT BREAKER/POLE SPACE ASSIGNMENTS SCHEDULED. 2. ALL ENCLOSURE HEIGHTS SHALL BE EQUAL. 3. (ST) = SHUNT TRIP CIRCUIT BREAKER					
		NEMA 1						MOUNTING: SURFACE					
CKT	TRIP	POLE	LOAD DESCRIPTION		CKT KVA	KVA PH-A PH-B PH-C		CKT KVA	LOAD DESCRIPTION		POLE	TRIP	CKT
3	-	-	HVU-CC-01		2.10	2.10		0.00	SPACE		3	-	2
5	-	-			2.10			0.00			-	-	4
7	20	3	HVU-CC-02		2.10	18.19		16.09	RMU-CC-01		3	80	8
9	-	-			2.10			18.19			-	-	10
11	-	-			2.10			18.19			-	-	12
13	20	3	EWH-CC-01		1.00	17.09		16.09	RMU-CC-02		3	80	14
15	-	-			1.00	17.09		16.09			-	-	16
17	-	-			1.00			17.09			-	-	18
19	20	3	VWR-CC-01-VWR-CC-01-04		3.67	19.76		16.09	RMU-CC-03		3	80	20
21	-	-			3.67	19.76		16.09			-	-	22
23	-	-			3.67			19.76			-	-	24
25	20	3	VWR-CC-01-08-VWR-CC-01-10		3.33	5.83		2.50	VWR-CC-02		3	20	26
27	-	-			3.33	5.83		2.50			-	-	28
29	-	-			3.33			5.83			-	-	30
31	20	3	VWR-CC-02-01		2.00	4.50		2.50	VWR-CC-03-01		3	20	32
33	-	-			2.00	4.50		2.50			-	-	34
35	-	-			2.00			4.50			-	-	36
37	20	3	VWR-CC-02-02		2.50	6.71		4.21	REF-CC-10/REF-CC-11		3	30	38
39	-	-			2.50	6.71		4.21			-	-	40
41	-	-			2.50			6.71			-	-	42
<input checked="" type="checkbox"/> MAIN LUGS <input checked="" type="checkbox"/> SUB-FEED LUGS													
CKT	TRIP	POLE	LOAD DESCRIPTION		CKT KVA	KVA PH-A PH-B PH-C		CKT KVA	LOAD DESCRIPTION		POLE	TRIP	CKT
43	20	1	VWR-CC-01-02		2.00	6.21		4.21	REF-CC-08/REF-CC-09		3	20	44
45	20	1	VWR-CC-01-11		4.00			8.21			-	-	46
47	20	1	VWR-CC-01-12		4.00			8.21			-	-	48
49	20	1	VWR-CC-01-06		1.50	5.71		4.21	REF-CC-02/REF-CC-03		3	30	50
51	20	1	VWR-CC-01-07		1.50	5.71		4.21			-	-	52
53	20	1	VWR-CC-01-08		4.00			8.21			-	-	54
55	20	1	VWR-CC-01-13		2.50	6.71		4.21	REF-CC-04/REF-CC-05		3	30	56
57	20	1	VWR-CC-02-05		4.00	8.21		4.21			-	-	58
59	20	1	VWR-CC-03-05		4.00	8.21		4.21	REF-CC-06/REF-CC-07		-	-	60
61	-	-	VWR-1		4.00	8.21		4.21			-	-	62
63	-	-			4.00	8.21		4.21			-	-	64
65	-	-			4.00			8.21			-	-	66
67	20	3	FP AIR COMPRESSOR		0.58	9.99		9.41	ELEVATOR		3	60 (ST)	68
69	-	-			0.58	9.99		9.41			-	-	70
71	-	-			0.58			9.99			-	-	72
73	1	SPACE			0.00	0.00		0.00	SHUNT TRIP COIL		-	-	74
75	1	SPACE			0.00	0.00		0.00	SPACE		1	76	76
77	1	SPACE			0.00	0.00		0.00	SPACE		1	68	78
79	1	SPACE			0.00	0.00		0.00	SPACE		1	80	80
81	1	SPACE			0.00	0.00		0.00	SPACE		1	82	82
					TOTAL CONNECTED PHASE KVA:		111.01						
					TOTAL CONNECTED KVA:		343.53						
					DEMAND OR DESIGN KVA:		287.14						
					FUTURE KVA:		75.00			AMPERES INTERRUPTING RATING: 35,000			
					TOTAL DEMAND OR DESIGN KVA:		342.14						
					DEMAND OR DESIGN AMPERES:		111.52						



RELAY PANEL 118-N-H-PP2-S1 SCHEDULE (INTERIOR WAREHOUSE LIGHTING)				
RELAY NUMBER	BRANCH CIRCUIT CONNECTION	LOAD	ZONE	
1	118-N-H-PP2-S1-1	WAREHOUSE HIGHBAY - 3 LAMPS	1A	
2	118-N-H-PP2-S1-3	WAREHOUSE HIGHBAY - 3 LAMPS	1B	
3	118-N-H-PP2-S1-5	WAREHOUSE HIGHBAY - 3 LAMPS	1A	
4	118-N-H-PP2-S1-7	WAREHOUSE HIGHBAY - 3 LAMPS	1B	
5	118-N-H-PP2-S1-9	WAREHOUSE HIGHBAY - 3 LAMPS	1A	
6	118-N-H-PP2-S1-11	WAREHOUSE HIGHBAY - 3 LAMPS	1B	
7	118-N-H-PP2-S1-13	WAREHOUSE HIGHBAY - 3 LAMPS	2A	
8	118-N-H-PP2-S1-15	WAREHOUSE HIGHBAY - 3 LAMPS	2B	
9	118-N-H-PP2-S1-17	WAREHOUSE HIGHBAY - 3 LAMPS	2A	
10	118-N-H-PP2-S1-19	WAREHOUSE HIGHBAY - 3 LAMPS	2B	
11	118-N-H-PP2-S1-21	WAREHOUSE HIGHBAY - 3 LAMPS	2A	
12	118-N-H-PP2-S1-23	WAREHOUSE HIGHBAY - 3 LAMPS	2B	
13	118-N-H-PP2-S1-2	WAREHOUSE HIGHBAY - 3 LAMPS	3A	
14	118-N-H-PP2-S1-4	WAREHOUSE HIGHBAY - 3 LAMPS	3B	
15	118-N-H-PP2-S1-6	WAREHOUSE HIGHBAY - 3 LAMPS	3A	
16	118-N-H-PP2-S1-8	WAREHOUSE HIGHBAY - 3 LAMPS	3B	
17	118-N-H-PP2-S1-10	WAREHOUSE HIGHBAY - 3 LAMPS	3A	
18	118-N-H-PP2-S1-12	WAREHOUSE HIGHBAY - 3 LAMPS	3B	
19	118-N-H-PP2-S1-14	WAREHOUSE HIGHBAY - 3 LAMPS	4A	
20	118-N-H-PP2-S1-16	WAREHOUSE HIGHBAY - 3 LAMPS	4B	
21	118-N-H-PP2-S1-18	WAREHOUSE HIGHBAY - 3 LAMPS	4A	
22	118-N-H-PP2-S1-20	WAREHOUSE HIGHBAY - 3 LAMPS	4B	
23	118-N-H-PP2-S1-25	WAREHOUSE UNDER MEZZANINE - 2 LAMPS	5A	
24	118-N-H-PP2-S1-27	WAREHOUSE UNDER MEZZANINE - 2 LAMPS	5B	
25	118-N-H-PP2-S1-22	WAREHOUSE UNDER MEZZANINE - 2 LAMPS	6A	
26	118-N-H-PP2-S1-24	WAREHOUSE UNDER MEZZANINE - 2 LAMPS	6B	
27		SPARE		
28		SPARE		
29		SPARE		
30		SPARE		
31		SPARE		
32		SPARE		
33		SPARE		
34		SPARE		
35		SPARE		
36		SPARE		

RELAY PANEL 118-N-H-PP3-S1 SCHEDULE - (EXTERIOR LIGHTING)				
RELAY NUMBER	BRANCH CIRCUIT CONNECTION	LOAD	ZONE	
1	118-N-H-PP3-S1-1	APRON BUILDING MOUNTED FLOODLIGHTS	PC*	
2	118-N-H-PP3-S1-2	APRON BUILDING MOUNTED FLOODLIGHTS	PC*	
3	118-N-H-PP3-S1-4	APRON BUILDING MOUNTED FLOODLIGHTS	PC*	
4	118-N-H-PP3-S1-6	APRON BUILDING MOUNTED FLOODLIGHTS	PC*	
5	118-N-H-PP3-S1-8	APRON BUILDING MOUNTED FLOODLIGHTS	PC*	
6	118-N-H-PP3-S1-10	APRON BUILDING MOUNTED FLOODLIGHTS	PC*	
7	118-N-H-PP3-S1-12	APRON BUILDING MOUNTED FLOODLIGHTS	PC*	
8	118-N-H-PP3-S1-14	APRON BUILDING MOUNTED FLOODLIGHTS	PC*	
9	118-N-H-PP3-S1-16	APRON BUILDING MOUNTED FLOODLIGHTS	PC*	
10	118-N-H-PP3-S1-18	APRON BUILDING MOUNTED FLOODLIGHTS	PC*	
11	118-N-H-PP3-S1-20	APRON POLE MOUNTED FLOODLIGHTS	PC*	
12	118-N-H-PP3-S1-22	APRON POLE MOUNTED FLOODLIGHTS	PC*	
13	118-N-H-PP3-S1-24	APRON POLE MOUNTED FLOODLIGHTS	PC*	
14	118-N-H-PP3-S1-3	TRUCK DOCK CANOPY LIGHTS	PC*	
15	118-N-H-PP3-S1-5	TRUCK DOCK CANOPY LIGHTS	PC*	
16	118-N-H-PP3-S1-7	BUILDING MOUNTED FLOODLIGHTS	PC*	
17	118-N-H-PP3-S1-9	BUILDING MOUNTED FLOODLIGHTS	PC*	
18	118-N-H-PP3-S1-11	BUILDING MOUNTED FLOODLIGHTS	PC*	
19	118-N-H-PP3-S1-13	BUILDING MOUNTED FLOODLIGHTS	PC*	
20		SPARE		
21		SPARE		
22		SPARE		
23		SPARE		
24		SPARE		
25		SPARE		
26		SPARE		
27		SPARE		
28		SPARE		
29		SPARE		
30		SPARE		
31		SPARE		
32		SPARE		
33		SPARE		
34		SPARE		
35		SPARE		
36		SPARE		

PC\* = PHOTOCELL CONTROLLED FOR DUSK TO DAWN OPERATION

RELAY PANEL 118-N-H-PP1-S2 SCHEDULE (EXTERIOR PARKING LIGHTS)				
RELAY NUMBER	BRANCH CIRCUIT CONNECTION	LOAD	ZONE	
1 (3-POLE)	118-N-H-PP1-S2-1,3,5	PARKING LOT LIGHTS	PC*	
2 (3-POLE)	118-N-H-PP1-S2-2,4,6	PARKING LOT LIGHTS	PC*	
3 (3-POLE)	118-N-H-PP1-S2-8,10,12	PARKING LOT LIGHTS	PC*	
4 (3-POLE)		SPARE		
5		SPARE		
6		SPARE		
7		SPARE		
8		SPARE		
9		SPARE		
10		SPARE		
11		SPARE		
12		SPARE		


PC\* = PHOTOCELL CONTROLLED FOR DUSK TO DAWN OPERATION

PANELBOARD: 101-N-H-PP1-S1										LOCATION: WAREHOUSE 101																			
TYPE: LIGHTING & APPLIANCE SERVICE: 480Y/277V, 3PH, 4W MAINS: 2253 MCB CABINET: NEMA 1										<input type="checkbox"/> FEED-THRU LUGS <input checked="" type="checkbox"/> SUB FEED LUGS										1. SUBMITTALS: CONTRACTOR SHALL NOT DEVIATE FROM CIRCUIT BREAKER/POLE SPACE ASSIGNMENTS SCHEDULED.									
										MOUNTING: SURFACE																			
CKT	TRIP	POLE	LOAD DESCRIPTION	CKT	KVA	PH-A	PH-B	PH-C	CKT	KVA	LOAD DESCRIPTION	POLE	TRIP	CKT															
1	20	3	OH DOORS/DOCK LEVELERS	2.33	4.66				2.33	OH DOORS/DOCK LEVELERS	3	20	2																
3	-	-	-	2.33	4.66				2.33	-	-	-	4																
5	-	-	-	2.33				4.66	2.33	-	-	-	6																
7	20	3	OH DOORS/DOCK LEVELERS	2.33	4.66				2.33	OH DOORS/DOCK LEVELERS	3	20	8																
9	-	-	-	2.33	4.66				2.33	-	-	-	10																
11	-	-	-	2.33				4.66	2.33	-	-	-	12																
13	20	3	OH DOORS/DOCK LEVELERS	2.33	4.66				2.33	OH DOORS/DOCK LEVELERS	3	20	14																
15	-	-	-	2.33				4.66	2.33	-	-	-	16																
17	-	-	-	2.33				4.66	2.33	-	-	-	18																
19	20	3	OH DOORS/DOCK LEVELERS	2.33	4.66				2.33	OH DOORS/DOCK LEVELERS	3	20	20																
21	-	-	-	2.33	4.66				2.33	-	-	-	22																
23	-	-	-	2.33				4.66	2.33	-	-	-	24																
25	20	3	OH DOORS/DOCK LEVELERS	2.33	2.33				0.00	SPACE	1	28																	
27	-	-	-	2.33				2.33	0.00	SPACE	1	28																	
29	-	-	-	2.33				2.33	0.00	SPACE	1	30																	
31	1	SPACE	0.00	0.00					0.00	SPACE	1	32																	
33	1	SPACE	0.00					0.00	0.00	SPACE	1	34																	
35	1	SPACE	0.00					0.00	0.00	SPACE	1	36																	
37	1	SPACE	0.00	0.00					0.00	SPACE	1	38																	
39	1	SPACE	0.00					0.00	0.00	SPACE	1	40																	
41	1	SPACE	0.00					0.00	0.00	SPACE	1	42																	
TRIP	POLE	LOAD DESCRIPTION	CKT	KVA	PH-A	PH-B	PH-C																						
50	3	XFMR 101-N-H-TR1-S1	0.72	0.72																									
-	-	-	0.72	0.72																									
-	-	-	1.20				1.20																						
TOTAL CONNECTED PHASE KVA:					21.69	21.69	22.17																						
TOTAL CONNECTED KVA:					65.55																								
DEMAND OR DESIGN KVA:					85.55																								
FUTURE KVA:					100.00																								
TOTAL DEMAND OR DESIGN KVA:					165.55																								
DEMAND OR DESIGN AMPERES:					188.13																								
										AMPERES INTERRUPTING RATING: 18,000																			

PANELBOARD: 101-N-L-PP1-S1					LOCATION: WAREHOUSE 101								
TYPE: LIGHTING & APPLIANCE					1 SUBMITTALS: CONTRACTOR SHALL NOT DEVIATE FROM CIRCUIT BREAKER/POLE SPACE ASSIGNMENTS SCHEDULED.								
SERVICE: 208Y/120V, 3PH, 4W													
MAINS: 1003 MCB													
CABINET: NEMA 1					<input type="checkbox"/> FEED-THRU LUGS								
					<input type="checkbox"/> SUB-FEED LUGS								
MOUNTING: SURFACE													
CKT	TRIP	POLE	LOAD DESCRIPTION	CKT	PH-A	KVA	PH-B	PH-C	CKT	LOAD DESCRIPTION	POLE	TRIP	CKT
1	20	1	RECEPTACLES	0.72	0.72				0.00	SPARE	1	20	2
3	20	1	RECEPTACLES	0.72		0.72			0.00	SPARE	1	20	4
5	20	1	IRH CONTROL POWER	1.20				1.20	0.00	SPARE	1	20	6
7	20	1	SPARE	0.00	0.00				0.00	SPARE	1	20	8
9	20	1	SPARE	0.00		0.00			0.00	SPARE	1	20	10
11	20	1	SPARE	0.00				0.00	0.00	SPARE	1	20	12
13	20	1	SPARE	0.00	0.00				0.00	SPARE	1	20	14
15	20	1	SPARE	0.00		0.00			0.00	SPARE	1	20	16
17	20	1	SPARE	0.00				0.00	0.00	SPARE	1	20	18
19	20	1	SPARE	0.00	0.00				0.00	SPARE	1	20	20
21	20	1	SPARE	0.00		0.00			0.00	SPARE	1	20	22
23	20	1	SPARE	0.00				0.00	0.00	SPARE	1	20	24
25	20	1	SPARE	0.00	0.00				0.00	SPARE	1	20	26
27	20	1	SPARE	0.00		0.00			0.00	SPARE	1	20	28
29	20	1	SPARE	0.00				0.00	0.00	SPARE	1	20	30
31	1	SPACE	0.00	0.00					0.00	SPACE	1		32
33	1	SPACE	0.00		0.00				0.00	SPACE	1		34
35	1	SPACE	0.00			0.00			0.00	SPACE	1		36
37	1	SPACE	0.00	0.00					0.00	SPACE	1		38
39	1	SPACE	0.00			0.00			0.00	SPACE	1		40
41	1	SPACE	0.00				0.00		0.00	SPACE	1		42
TOTAL CONNECTED PHASE KVA:					0.72	0.72	1.20	AMPERES INTERRUPTING RATING: 10,000					
TOTAL CONNECTED KVA:					2.64								
FUTURE KVA:					27.36								
TOTAL DEMAND OR DESIGN KVA:					30.00								
DEMAND OR DESIGN AMPERES:					83.27								

PANELBOARD: 101-N-H-PP2-S1 LOCATION: WAREHOUSE 101									
TYPE: LIGHTING & APPLIANCE SERVICE: 480Y/277V, 3PH, 4W MAINS: 2253 MCB CABINET: NEMA 1					1. SUBMITTALS: CONTRACTOR SHALL NOT DEVIATE FROM CIRCUIT BREAKER/POLE SPACE ASSIGNMENTS SCHEDULED.				
CKT	TRIP	POLE	LOAD DESCRIPTION	CKT	PH-A	PH-B	PH-C	CKT	LOAD DESCRIPTION
1	20	3	OH DOORS/DOCK LEVELERS	2.33	4.66			2.33	OH DOORS/DOCK LEVELERS
3	-	-	-	2.33		4.66		2.33	-
5	-	-	-	2.33			4.66	2.33	-
7	20	3	OH DOORS/DOCK LEVELERS	2.33	4.66			2.33	OH DOORS/DOCK LEVELERS
9	-	-	-	2.33		4.66		2.33	-
11	-	-	-	2.33			4.66	2.33	-
13	20	3	OH DOORS/DOCK LEVELERS	1.16	3.49			2.33	OH DOORS/DOCK LEVELERS
15	-	-	-	1.16		3.49		2.33	-
17	-	-	-	1.16			3.49	2.33	-
19	20	3	OH DOORS/DOCK LEVELERS	2.33	4.66			2.33	OH DOORS/DOCK LEVELERS



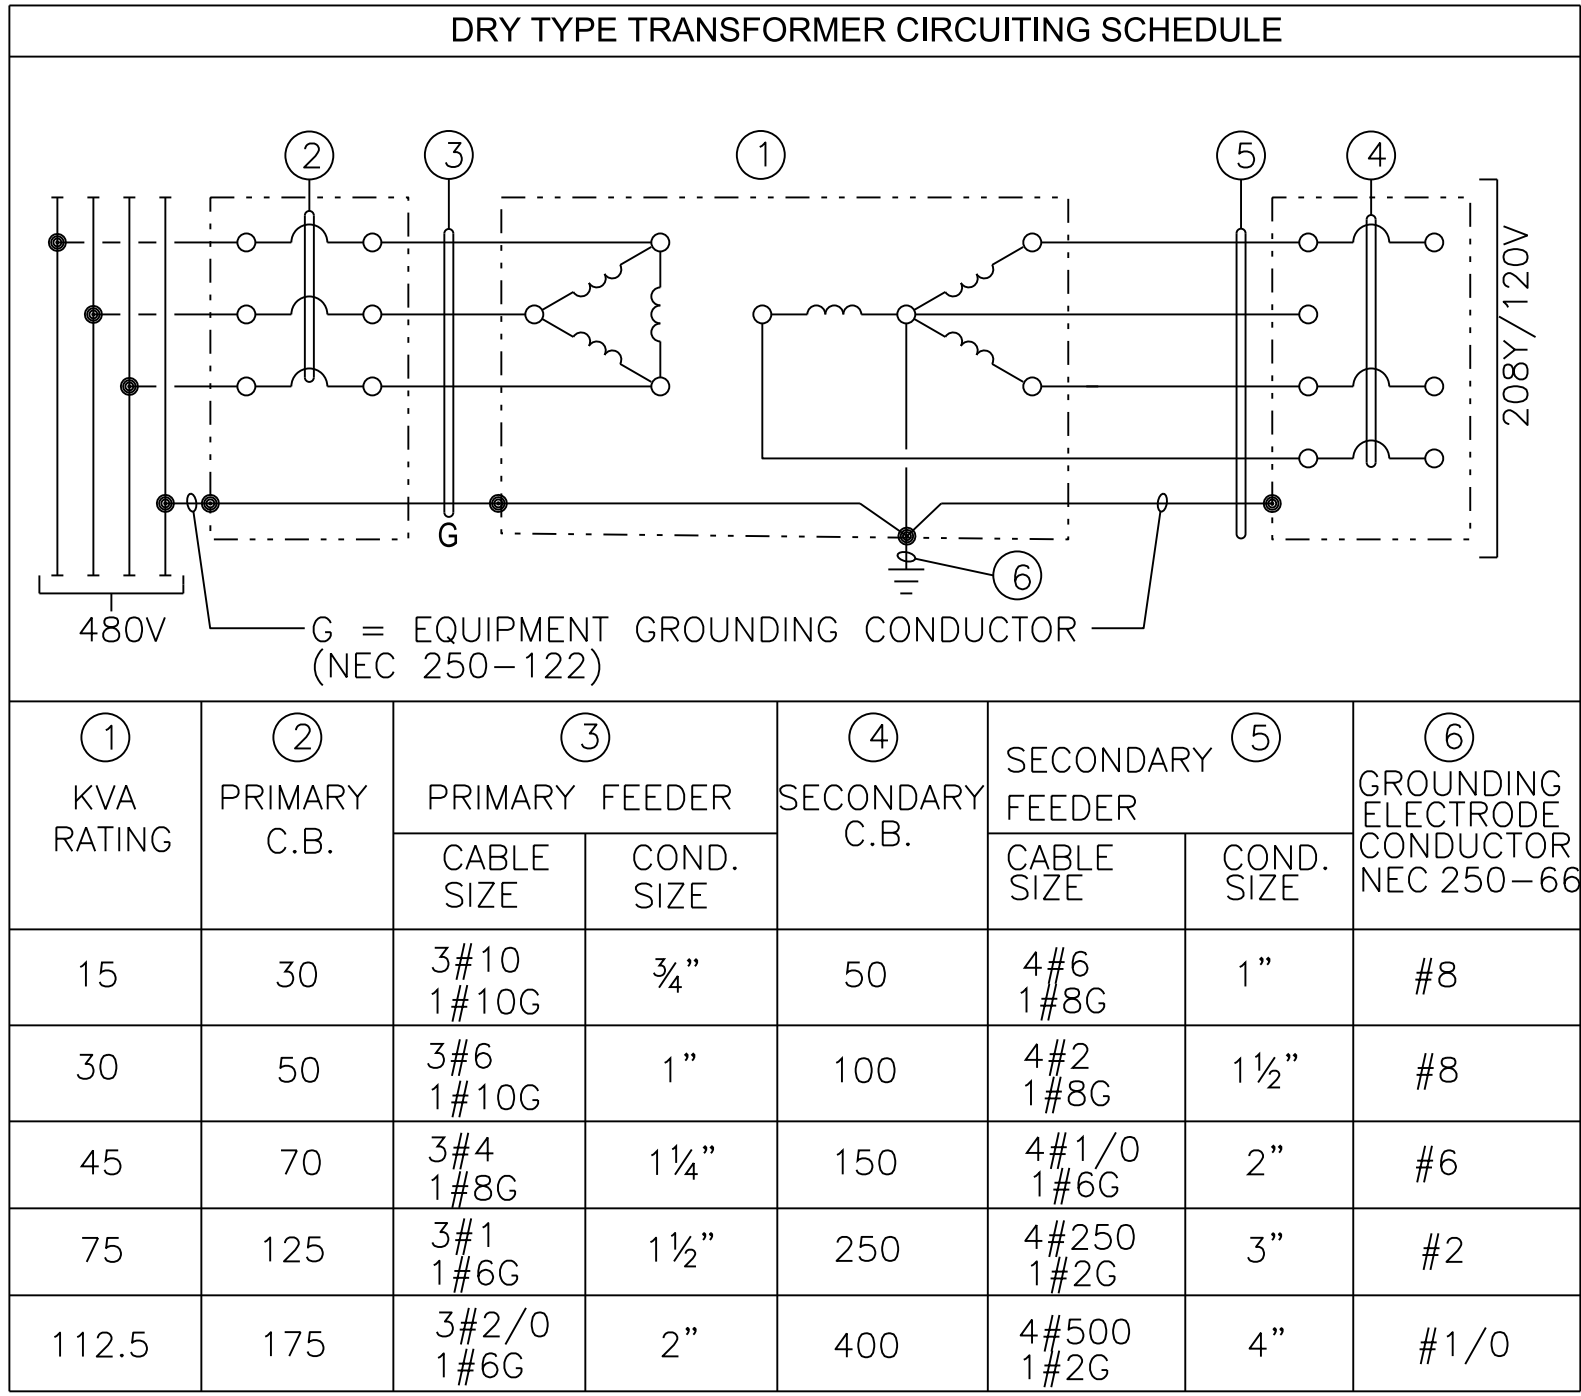

**GENERAL NOTES:** (APPLIES TO THIS DRAWING ONLY)

2. SERVICE ENTRANCE SWITCHBOARD SHALL BE FIELD LABELED TO INCLUDE THE MAXIMUM AVAILABLE SHORT CIRCUIT CURRENT IN ACCORDANCE WITH NEC ARTICLE 110.24(A). FIELD LABEL SHALL BE FROM STUDY PERFORMED BY CONTRACTOR, NOT FROM DESIGN DOCUMENTS AND SHALL INCLUDE DATE OF STUDY.



CITY OF ATLANTA, GEORGIA

Hartsfield-Jackson  
Atlanta International Airport

HEERY INTERNATIONAL, INC. 99

PEACHTREE STREET, NE  
ATLANTA, GA 30309  
PHONE: 404.419.9190  
FAX: 404.946.2017

MATRIX 3D

44 BROAD STREET  
ATLANTA, GA 30303  
PHONE: 404.522.3800  
FAX: 404.522.3800

STEVENS & WILKINSON, INC.  
103 PEACHTREE STREET NW, SUITE 2500  
ATLANTA, GA 30303  
PHONE: 404.522.8888  
FAX: 404.521.6204

SOUTHEASTERN ENGINEERING, INC. (S)  
2470 SANDY PLAINS ROAD  
MARIETTA, GA 30066  
PHONE: 770.321.3936  
FAX: 770.321.3935

NO.	DATE	BY	REVISION
-----	------	----	----------

AIR CARGO BUILDING C

### ELECTRICAL SINGLE LINE DIAGRAM

WBS NUMBER:  
D.07.55.009

DRAWN BY:  
M. TRINKER

FC-6006007929-A

DESIGNED BY:  
M. TRINKER

A/E PROJECT NUMBER  
H11-073062

CHECKED BY:  
S. SVEDA

DATE: \_\_\_\_\_

11/25/2014

NONE

SHEET NO:

### E 6.1.1

SE.

10 AIR CARGO BUILDING C. 100% CONSTRUCTION DOCUMENTS ISSUED FOR BID. NOVEMBER 25, 2014

NOT RELEASED FOR CONSTRUCTION

Hartsfield-Jackson  
Atlanta International Airport

HEERY INTERNATIONAL, INC. 999  
PEACHTREE STREET, NE  
ATLANTA, GA 30309  
PHONE: 404.419.9190  
FAX: 404.946.2017

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FAX: 404.522.3862

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FAX: 404.521.6204

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MARIETTA, GA 30066  
PHONE: 770.321.3936  
FAX: 770.321.3936





NO.	DATE	BY	REVISION
AIR CARGO BUILDING C			
CARGO BUILDING D ELECTRICAL POWER RISER DIAGRAMS			
ISS NUMBER: D 07.55.009		DRAWN BY: M. TRINKER	
FC NUMBER: FC-4906007929-A		DESIGNED BY: M. TRINKER	
A/E PROJECT NUMBER: HII-0730621		CHECKED BY: S. SVEDA	
		APPROVED BY:	
		DATE: 11/25/2014	
		SCALE: NONE	
		SHEET NO.:	
E 6.1.2			


HAIR CARGO BU11 DING C. 100% CONSTRUCTION DOCUMENTS ISSUED FOR BID NOVEMBER 25, 2014

NOT RELEASED FOR CONSTRUCTION



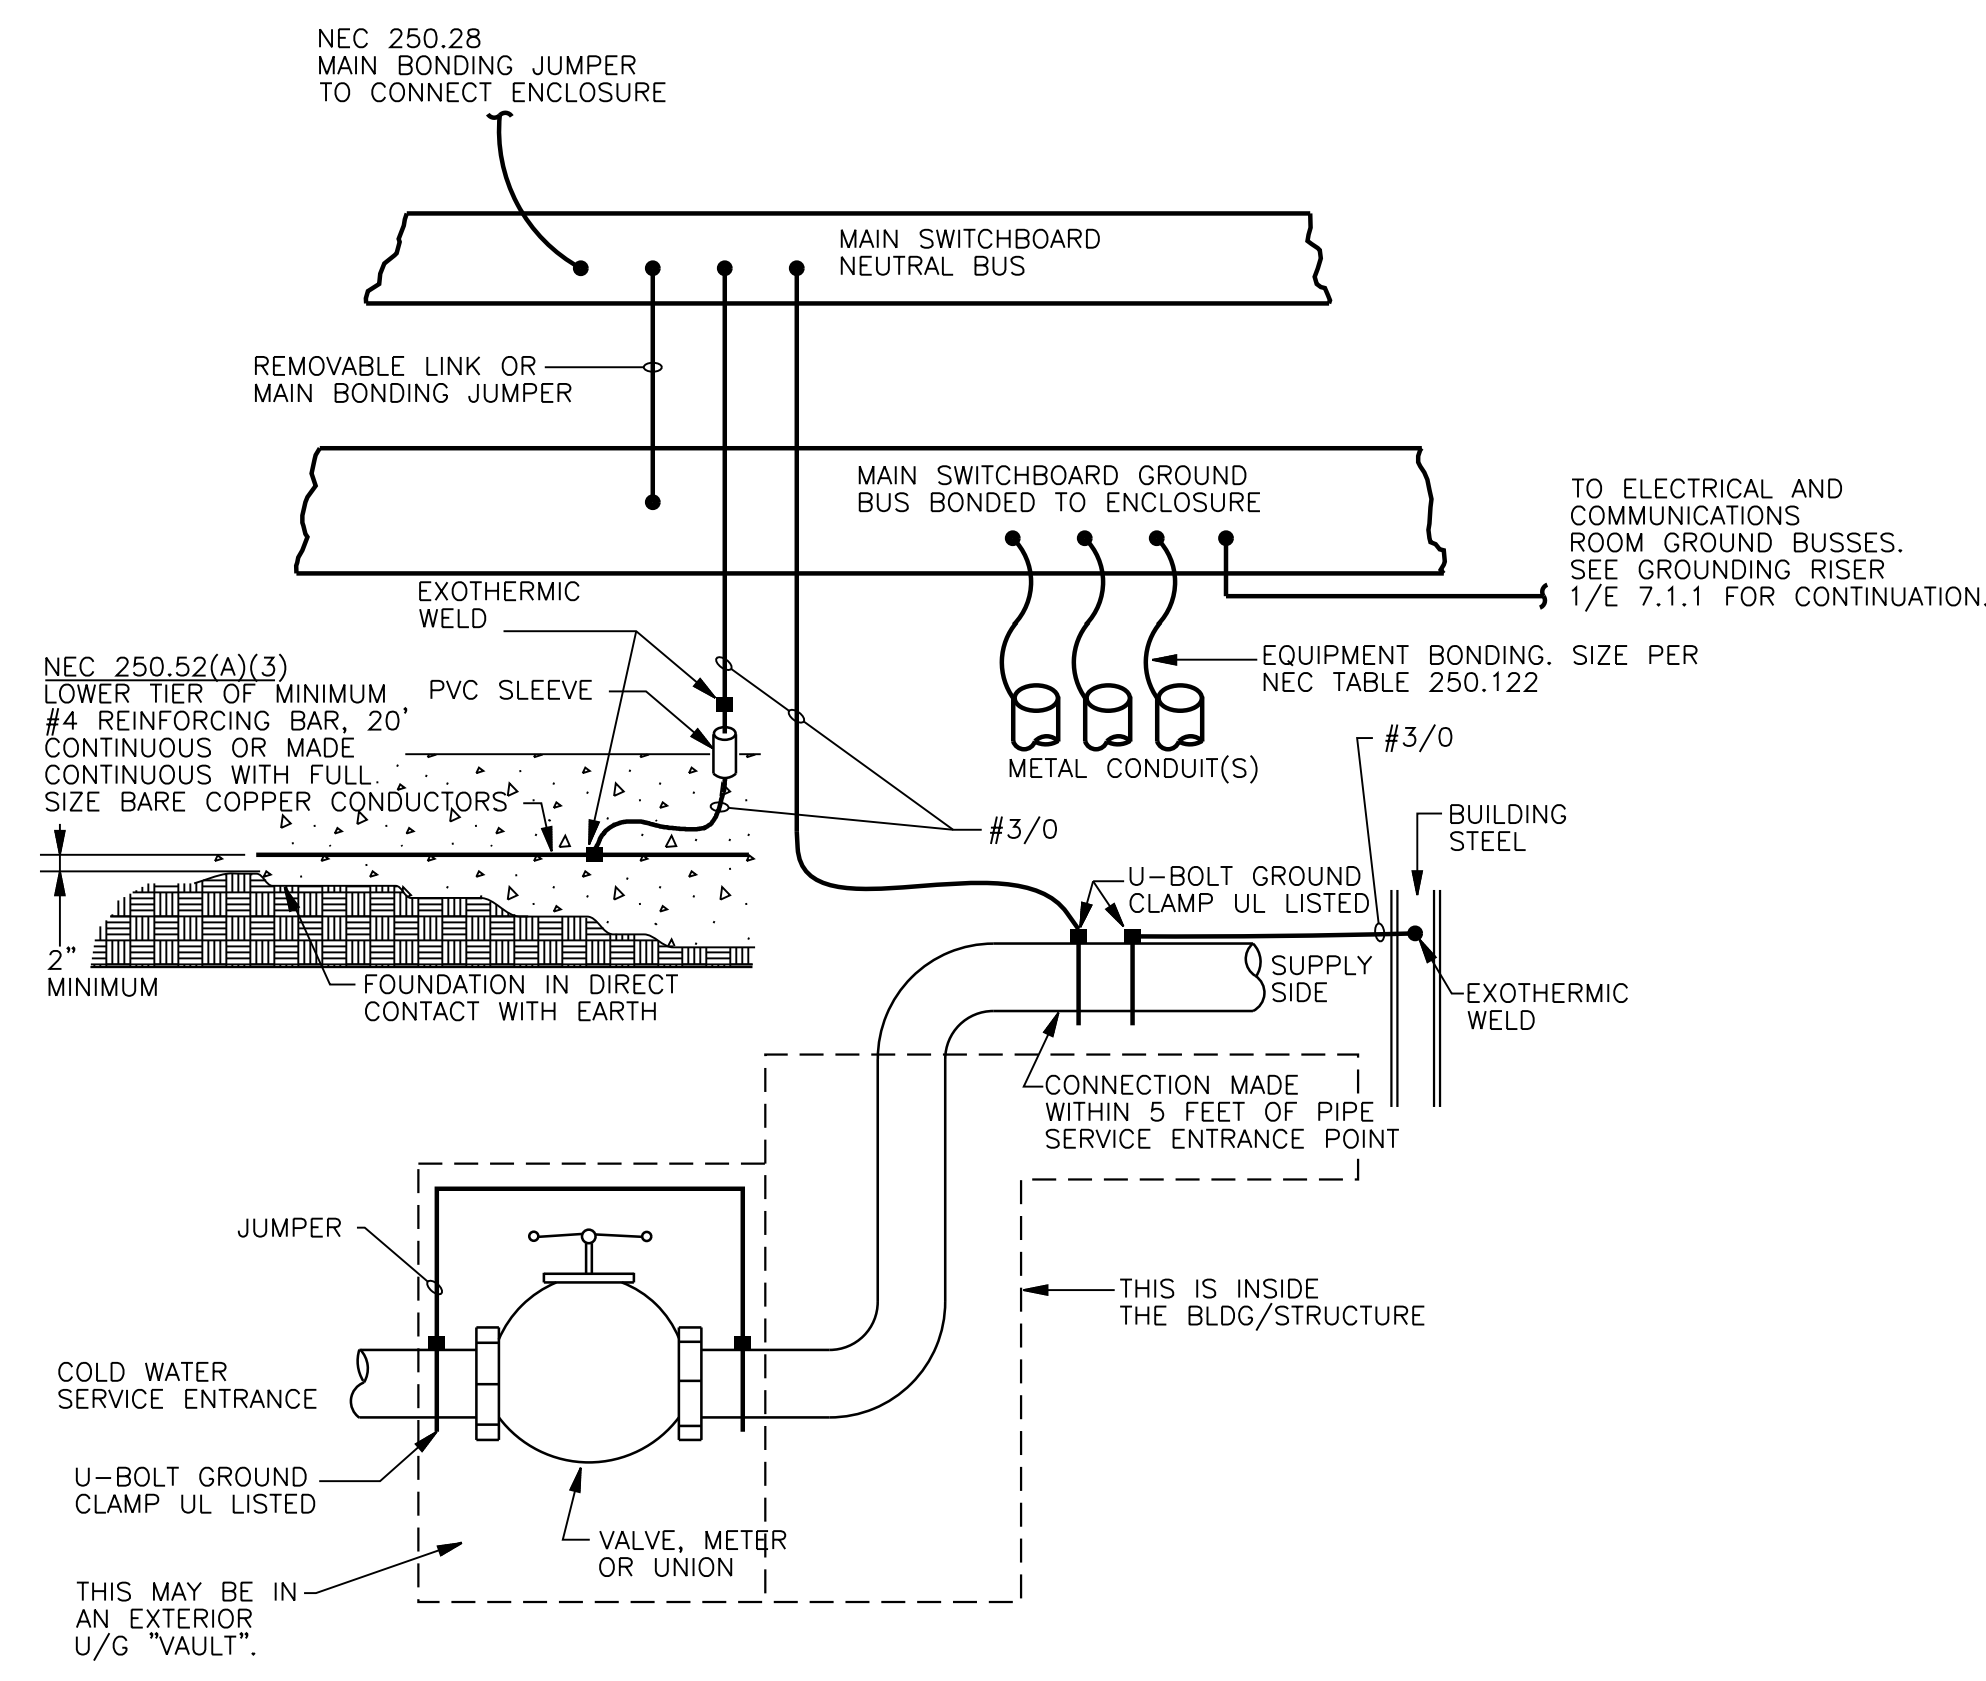


2 SERVICE ENTRANCE GROUNDING SYSTEM  
E 7.1.1 SCALE: NONE

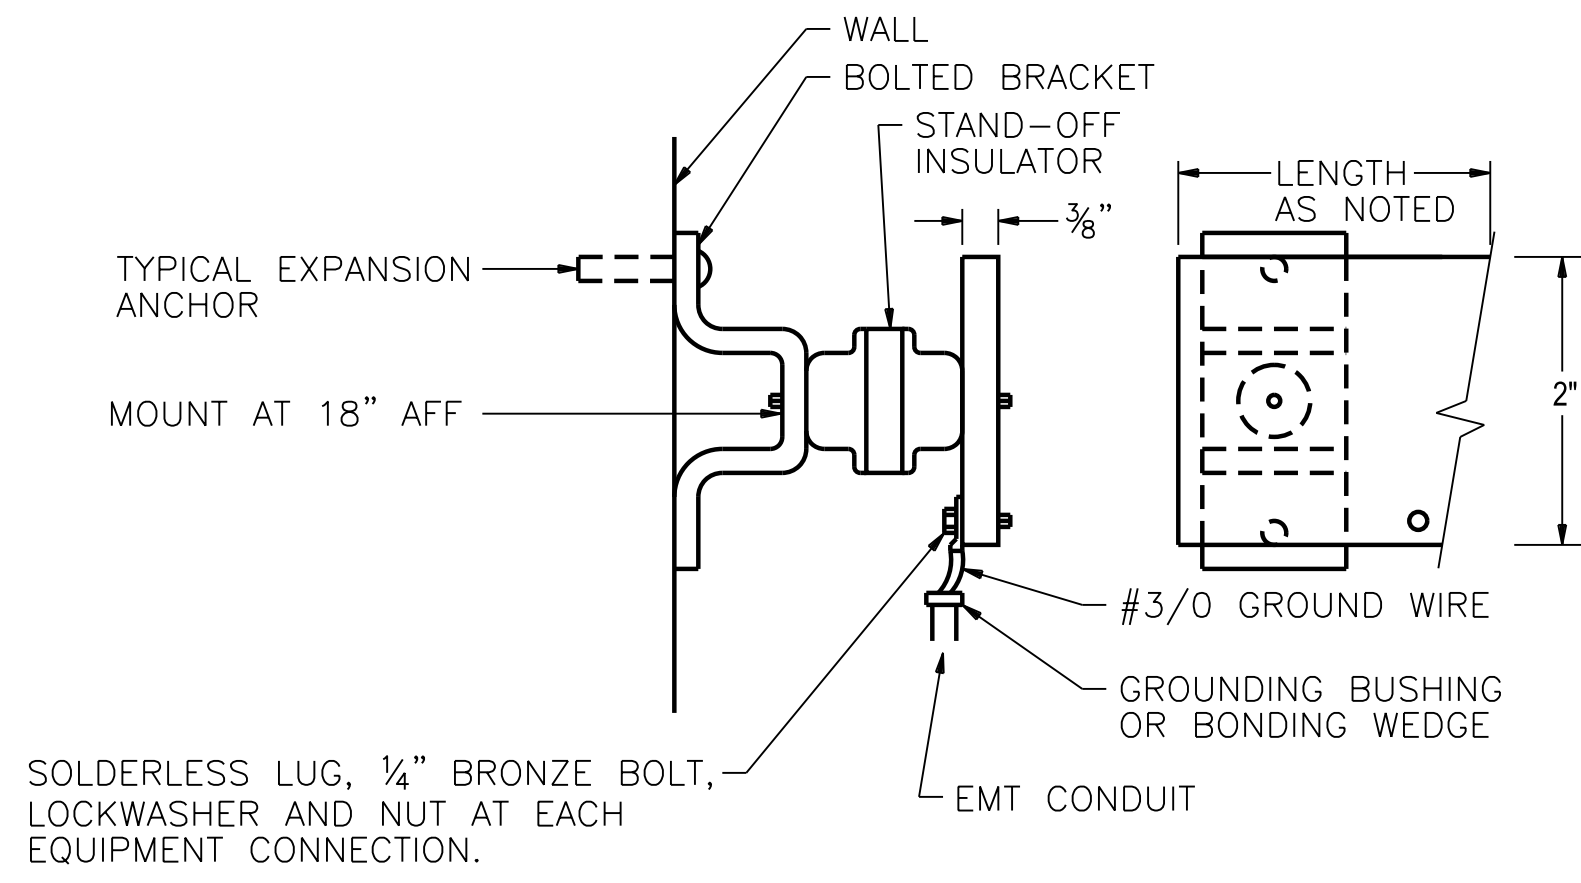

3 GROUND BUS MOUNTING DETAIL  
E 7.1.1 SCALE: NONE

GENERAL NOTES:

1. FOR ELECTRICAL RATINGS OF TRANSFORMERS, REFER TO ELECTRICAL SINGLE LINE DIAGRAM ON SHEET E 6.1.1.
2. FOR TRANSFORMER EQUIPMENT GROUNDING CONDUCTOR SIZES, REFER TO DRY TYPE TRANSFORMER CIRCUITING SCHEDULE ON SHEET E 6.1.1.
3. FOR GROUND BUS MOUNTING DETAIL, REFER TO DETAIL NO. 2 ON THIS DRAWING.
4. ALL GROUND WIRES SHALL BE ROUTED IN 3/4" MINIMUM EMT CONDUIT UNO.

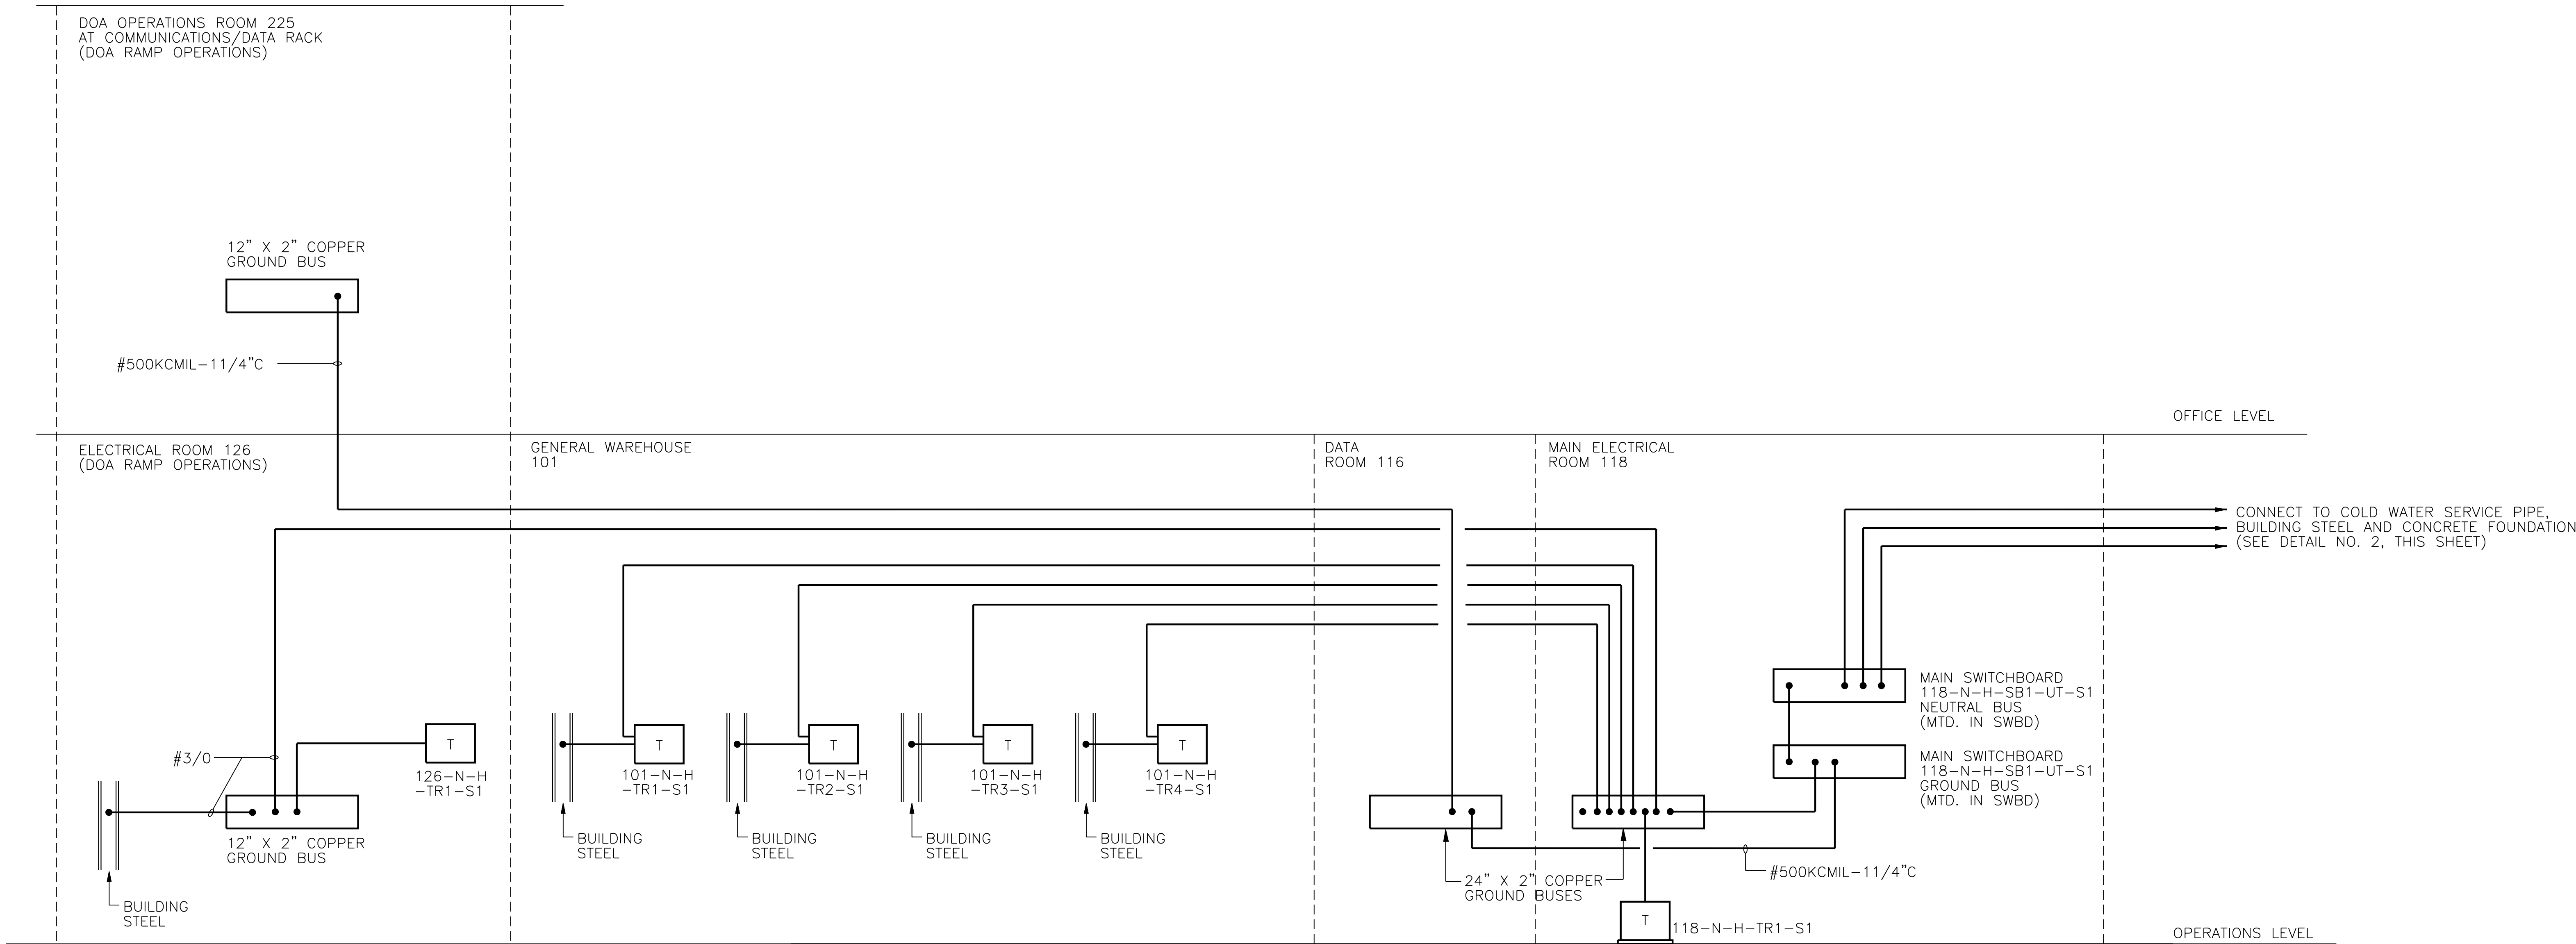

1 GROUNDING RISER DIAGRAM  
E 7.1.1 SCALE: NONE



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201 SANDY PLAINS ROAD  
MARIETTA, GA 30066  
PHONE: 770.321.9038  
FAX: 770.321.3935

AIR CARGO BUILDING C

GROUNDING RISER  
DIAGRAM

WBS NUMBER: D.07.55.009  
FC NUMBER: FC-6006007529-A  
A/E PROJECT NUMBER: HII-0730621  
DRAWN BY: M. TRINKER  
DESIGNED BY: M. TRINKER  
CHECKED BY: S. SVEDA  
APPROVED BY: S. SVEDA

DATE: 11/25/2014  
SCALE: NONE  
SHEET NO: E 7.1.1

SEAL

LIGHTING CONTROL RELAY PANELS ADJACENT TO PANELBOARDS IN ELEC ROOM 118

118-N-H-PP2-S1

118-N-H-PP3-S1

118-N-H-PP1-S2

PHOTOCELL MOUNTED TO ROOF  
PARAPHET AT NORTHEAST CORNER  
ABOVE ENTRY LOBBY

PC

118-N-L-PP2-S1-14

MASTER LIGHTING CONTROL PANEL  
WITH INTEGRAL TIME CLOCK  
(DATA ROOM 116)

CONTROL STATIONS AT AIRSIDE DOORS

1

1

NEAR COL  
LINE 4

NEAR COL  
LINE 12

CONTROL STATIONS AT LANDSIDE DOORS

2

4

3

SOUTH  
TRUCK  
DOCK  
ENTRY

MAIN  
ENTRY  
FROM  
LOBBY

NORTH  
TRUCK  
DOCK  
ENTRY

#### LIGHTING CONTROL SYSTEM KEYED NOTES:

- 2 BUTTON ZONE CONTROL STATION WITH SINGLE BUTTON CONTROLLING ZONES 1A,1B, 2A, 2B, 5A, 5B AND SINGLE BUTTON CONTROLLING ZONES 3A, 3B, 4A, 4B, 6A, 6B.
- 8 BUTTON ZONE CONTROL STATION WITH INDIVIDUAL BUTTONS CONTROLLING ZONES 1A,1B, 2A, 2B, 5A, 5B AND SINGLE BUTTON CONTROLLING ALL ZONES ON-OFF.
- 8 BUTTON ZONE CONTROL STATION WITH INDIVIDUAL BUTTONS CONTROLLING ZONES 3A, 3B, 4A, 4B, 6A, 6B AND SINGLE BUTTON CONTROLLING ALL ZONES ON-OFF.
- 14 BUTTON (MINIMUM) MASTER CONTROL STATION WITH INDIVIDUAL BUTTONS CONTROLLING ALL 12 INDIVIDUAL ZONES, AND SINGLE BUTTON CONTROLLING ALL ZONES ON-OFF.

2

E 7.1.2

#### LIGHTING CONTROL SYSTEM RISER DIAGRAM

SCALE: NONE

SEE RELAY PANEL SCHEDULES, SHEET E 5.1.2 FOR  
BRANCH CIRCUIT ZONE ASSIGNMENTS

3

E 7.1.2

#### FIRE ALARM SYSTEM RISER DIAGRAM

SCALE: NONE

##### RISER NOTES:

- PROVIDE FULLY ADDRESSABLE ALARM DEVICES AND MULTIPLEX WIRING PER MANUFACTURER'S DIRECTIONS.
- RISER DOES NOT INDICATE TOTAL QUANTITY OF DEVICES, ONLY TYPICAL REQUIREMENTS. SEE SYSTEMS FLOOR PLANS FOR ALL LOCATIONS AND QUANTITIES OF DEVICES REQUIRED.
- ALL FIRE ALARM WIRING WILL BE RUN COMPLETE IN 3/4" CONDUIT FROM DEVICE LOCATION OUTLET BOXES TO EQUIPMENT PANELS. CONDUITS FOR FIRE ALARM SHALL BE DEDICATED AS SUCH, AND SHALL CONTAIN NO OTHER SYSTEMS WIRING.

FA REMOTE  
ANNUNCIATOR  
DOA OPERATIONS  
LOBBY  
121

FA REMOTE  
ANNUNCIATOR  
CUSTOMER  
SERVICE  
111

FACP  
ELEC ROOM  
118

120V POWER  
(SEE E 3.1.1)

TO DOA MONITORING AS  
DIRECTED BY OWNER

TYPICAL INITIATING DEVICE/SIGNALING LINE CIRCUIT.  
MAXIMUM NUMBER OF POINTS PER  
MANUFACTURERS REQUIREMENTS

TYPICAL NOTIFICATION ALARM CIRCUIT.  
MAXIMUM NUMBER OF DEVICES PER  
MANUFACTURERS REQUIREMENTS

#### MESH AP EQUIPMENT NOTES:

- PROVIDE WIND LOAD CALCULATION FOR P&D APPROVAL OF STEEL POLE AND MESH AP ASSEMBLY INSTALLATION. COORDINATE WITH STRUCTURAL FOR MOUNTING OF POLE TO BUILDING.
- INSTALL WEATHERHEAD AD CAT 6 CABLE FROM AP TO THE DOA LOCKABLE CABINET COMPLETE.
- PROVIDE OUTDOOR MESH AP WITH ALL ASSOCIATED PARTS AND MOUNT TO POLE PER MANUFACTURER'S SPECIFICATIONS. MESH AP SHALL BE CISCO 1572 SERIES, MODEL NUMBER: AIR-AP1572ECx-x-K9.

#### DATA CABINET EQUIPMENT: (MODEL NUMBERS SUBJECT TO CHANGE BY VENDOR)

- PROVIDE THE FOLLOWING COMPONENTS AND INSTALL IN BOTH CABINETS AS DIRECTED BY DIT:  
(1 EA) 24 PORT MODULAR FIBER PATCH PANEL, CORNING CCH.
- PROVIDE THE FOLLOWING EQUIPMENT AND INSTALL IN CABINET AT ROOM 226 AS DIRECTED BY DIT:  
(1) CISCO SWITCH, MODEL WS-C3750X-48P-S  
(2) CISCO TRANSCEIVERS, MODEL GLC-LH-SMD  
(1) 24 PORT CAT 6 PATCH PANEL.

MESH AP MOUNTED  
TO TOP OF POLE

STEEL POLE  
EXTENDING  
10FT ABOVE  
ROOF HEIGHT

WEATHERHEAD

DOA OPERATIONS ROOM 225  
(DOA RAMP OPERATIONS)

DOA LOCKABLE CABINET,  
CHATSWORTH M SERIES  
19" X 36" X 72"

(1) 1" C WITH CAT 6 CABLE TO EXTERIOR OF AIRSIDE WALL  
AT COLUMN LINE A-22 AT ROOF ELEVATION FOR CONNECTION  
TO MESH AP SERVING DOA OPERATIONS SPACE.

(1) CAT 6 CABLE PER ACTIVATED PORT IN 1" C  
(TYPICAL)

2D/1V NUMBER AND TYPE  
OF ACTIVATED PORTS

TYPICAL OUTLET  
(4 PORTS WITH NUMBER  
OF ACTIVATED LINES AS  
NOTED)

STORAGE ROOM 125  
(DOA RAMP OPERATIONS)

GENERAL WAREHOUSE  
101

DATA ROOM  
116

DOA LOCKABLE CABINET,  
CHATSWORTH M SERIES  
19" X 36" X 72"

1

E 7.1.2

#### COMMUNICATIONS/DATA RISER DIAGRAM

SCALE: NONE

(4) EMPTY CONDUITS FOR FUTURE TENANT  
COMMUNICATIONS SERVICES

(4) 4" C TO AT&T PULLBOX AT  
LOOP ROAD. SEE ELECTRICAL  
SITE PLANS E 1.2.1 & E 1.2.2  
FOR CONTINUATION



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Hartsfield-Jackson  
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STEVENS & WEAVERSON, INC.  
100 PEACHTREE STREET NW, SUITE 2000  
ATLANTA, GA 30303  
PHONE: 404.522.6888  
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SOUTHEASTERN ENGINEERING, INC. (SEI)  
201 SANDY PLAINS ROAD  
MARIETTA, GA 30066  
PHONE: 770.321.9308  
FAX: 770.321.3935

NO. DATE BY REVISION

AIR CARGO BUILDING C

ELECTRICAL SYSTEMS  
RISER DIAGRAMS

WBS NUMBER:  
D.07.55.009

DRAWN BY:  
M. TRINKER

FC NUMBER:  
FC-6006007529-A

DESIGNED BY:  
M. TRINKER

A/E PROJECT NUMBER:  
HII-0730621

CHECKED BY:  
S. SVEDA

APPROVED BY:  
S. SVEDA


DATE:  
11/25/2014

SCALE:  
NONE


SHEET NO:  
E 7.1.2

SEAL




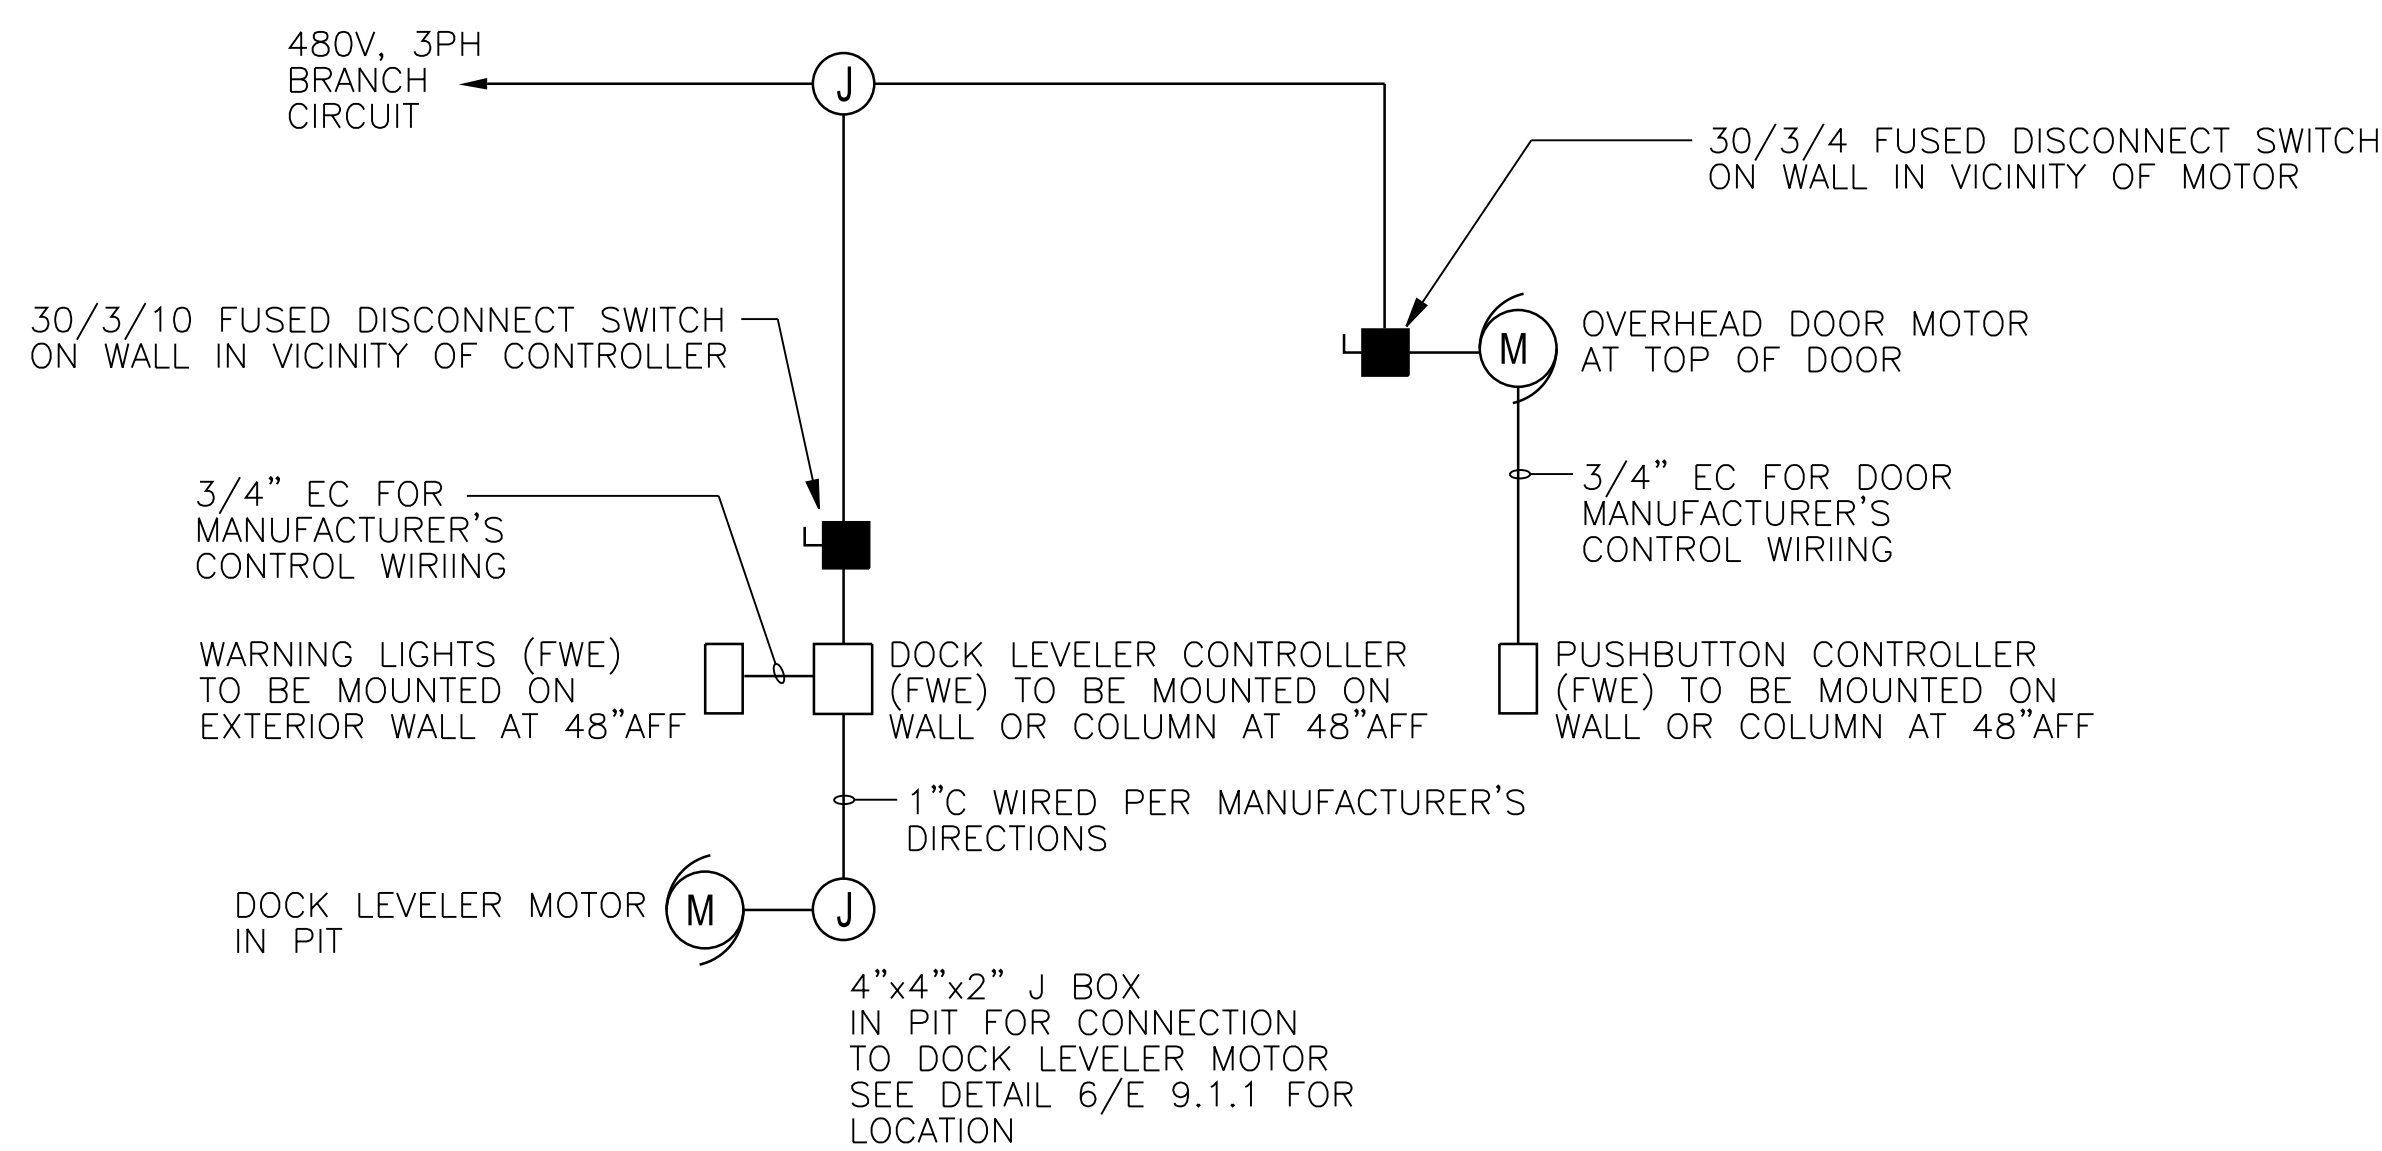


1 OVERHEAD DOOR & DOCK LEVELER CONNECTION DETAIL  
E 9.1.1 SCALE: NONE

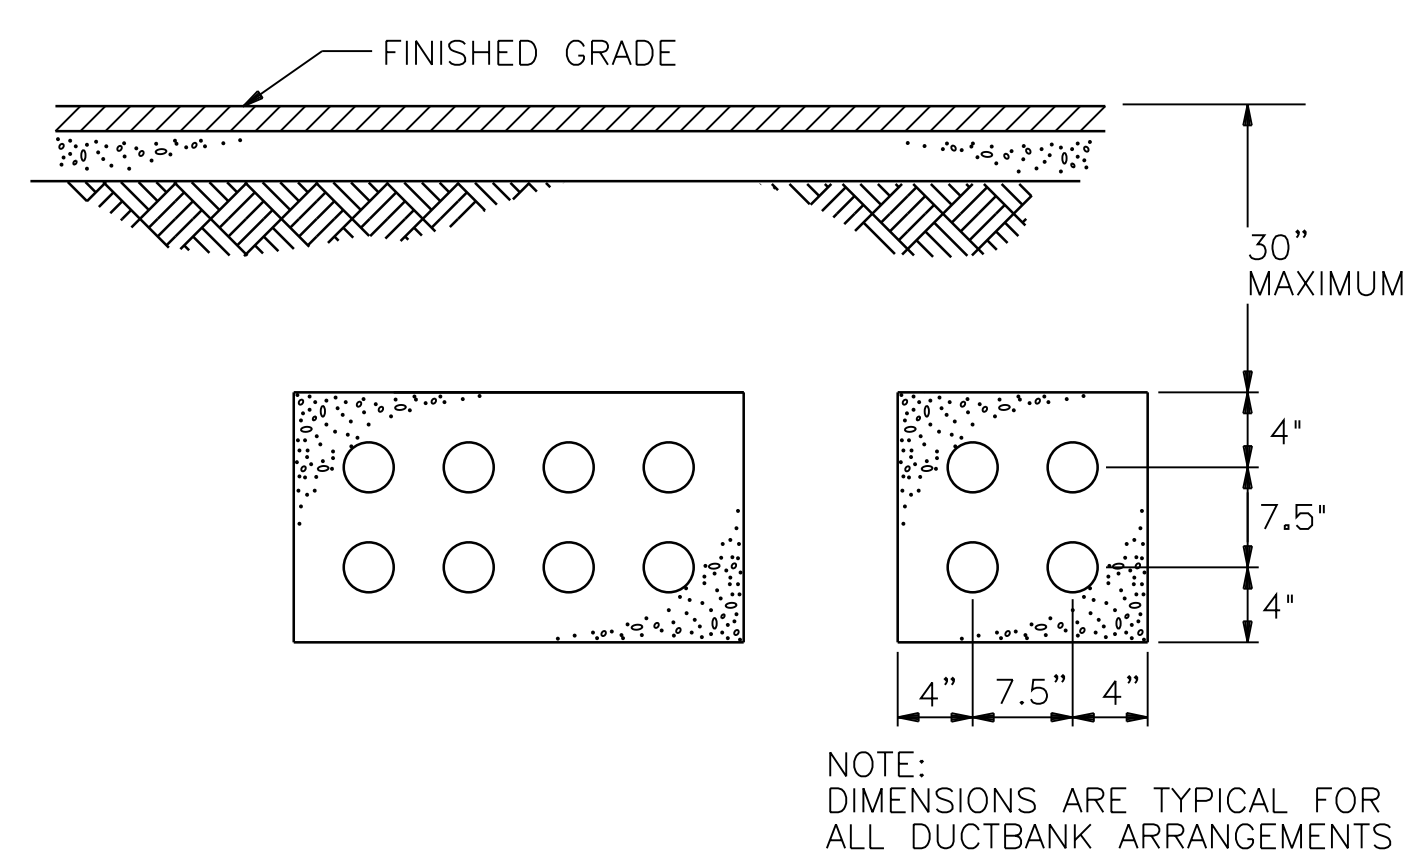

2 TYPICAL CONDUIT DUCTBANK DETAIL  
E 9.1.1 SCALE: NONE

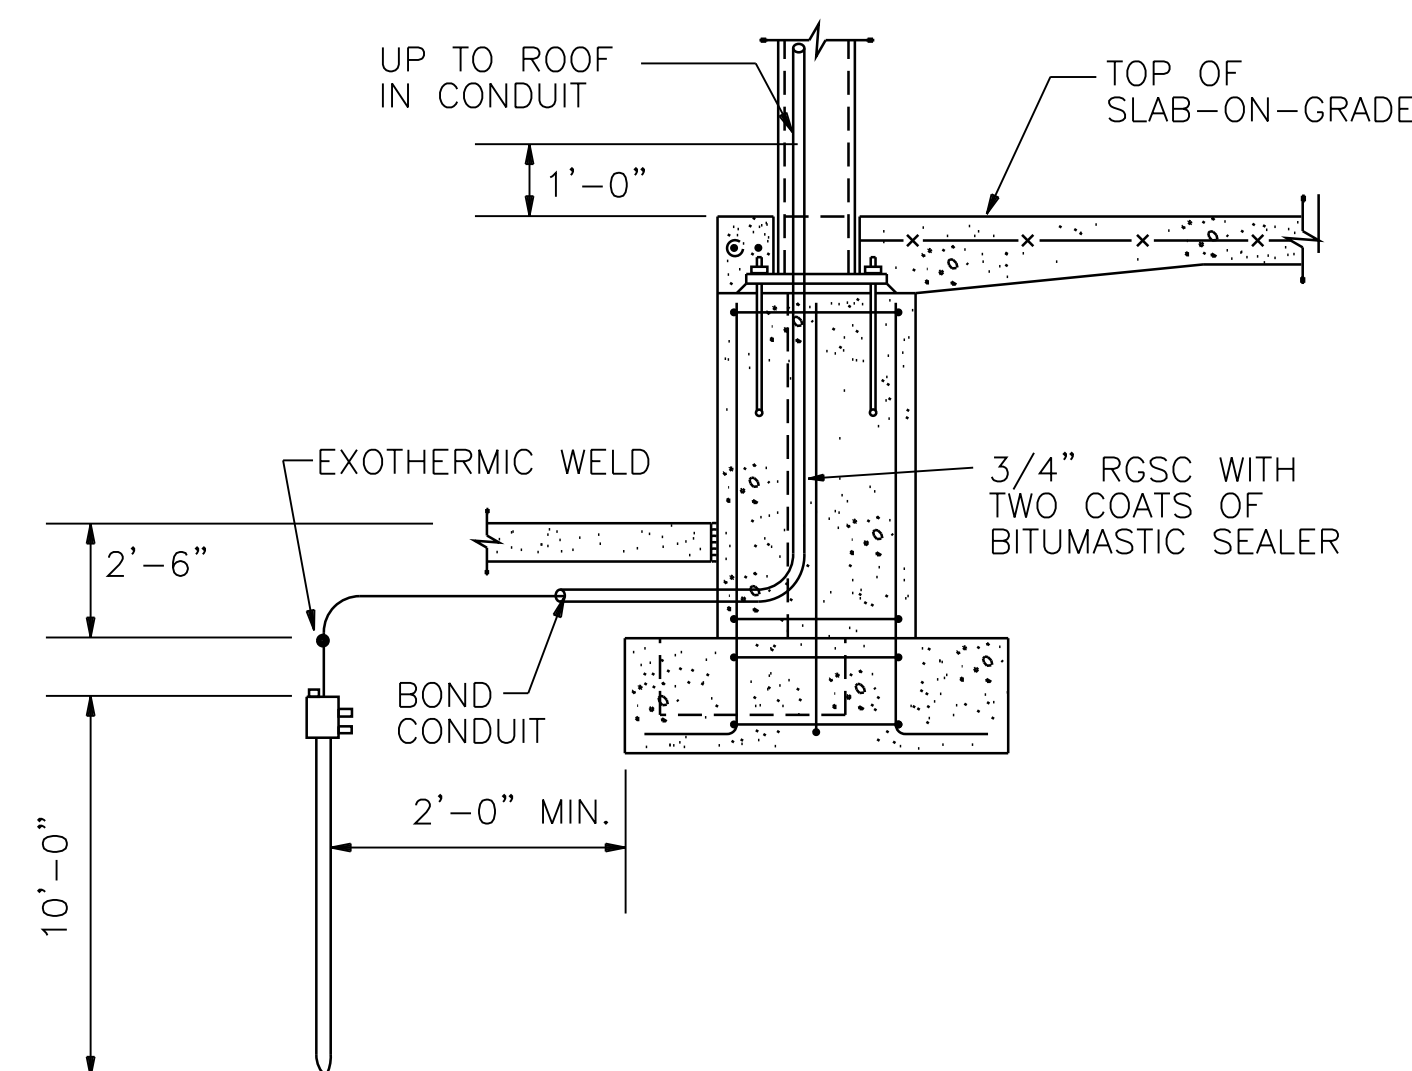


3 GROUND ROD CONNECTION DETAIL  
E 9.1.1 SCALE: NONE

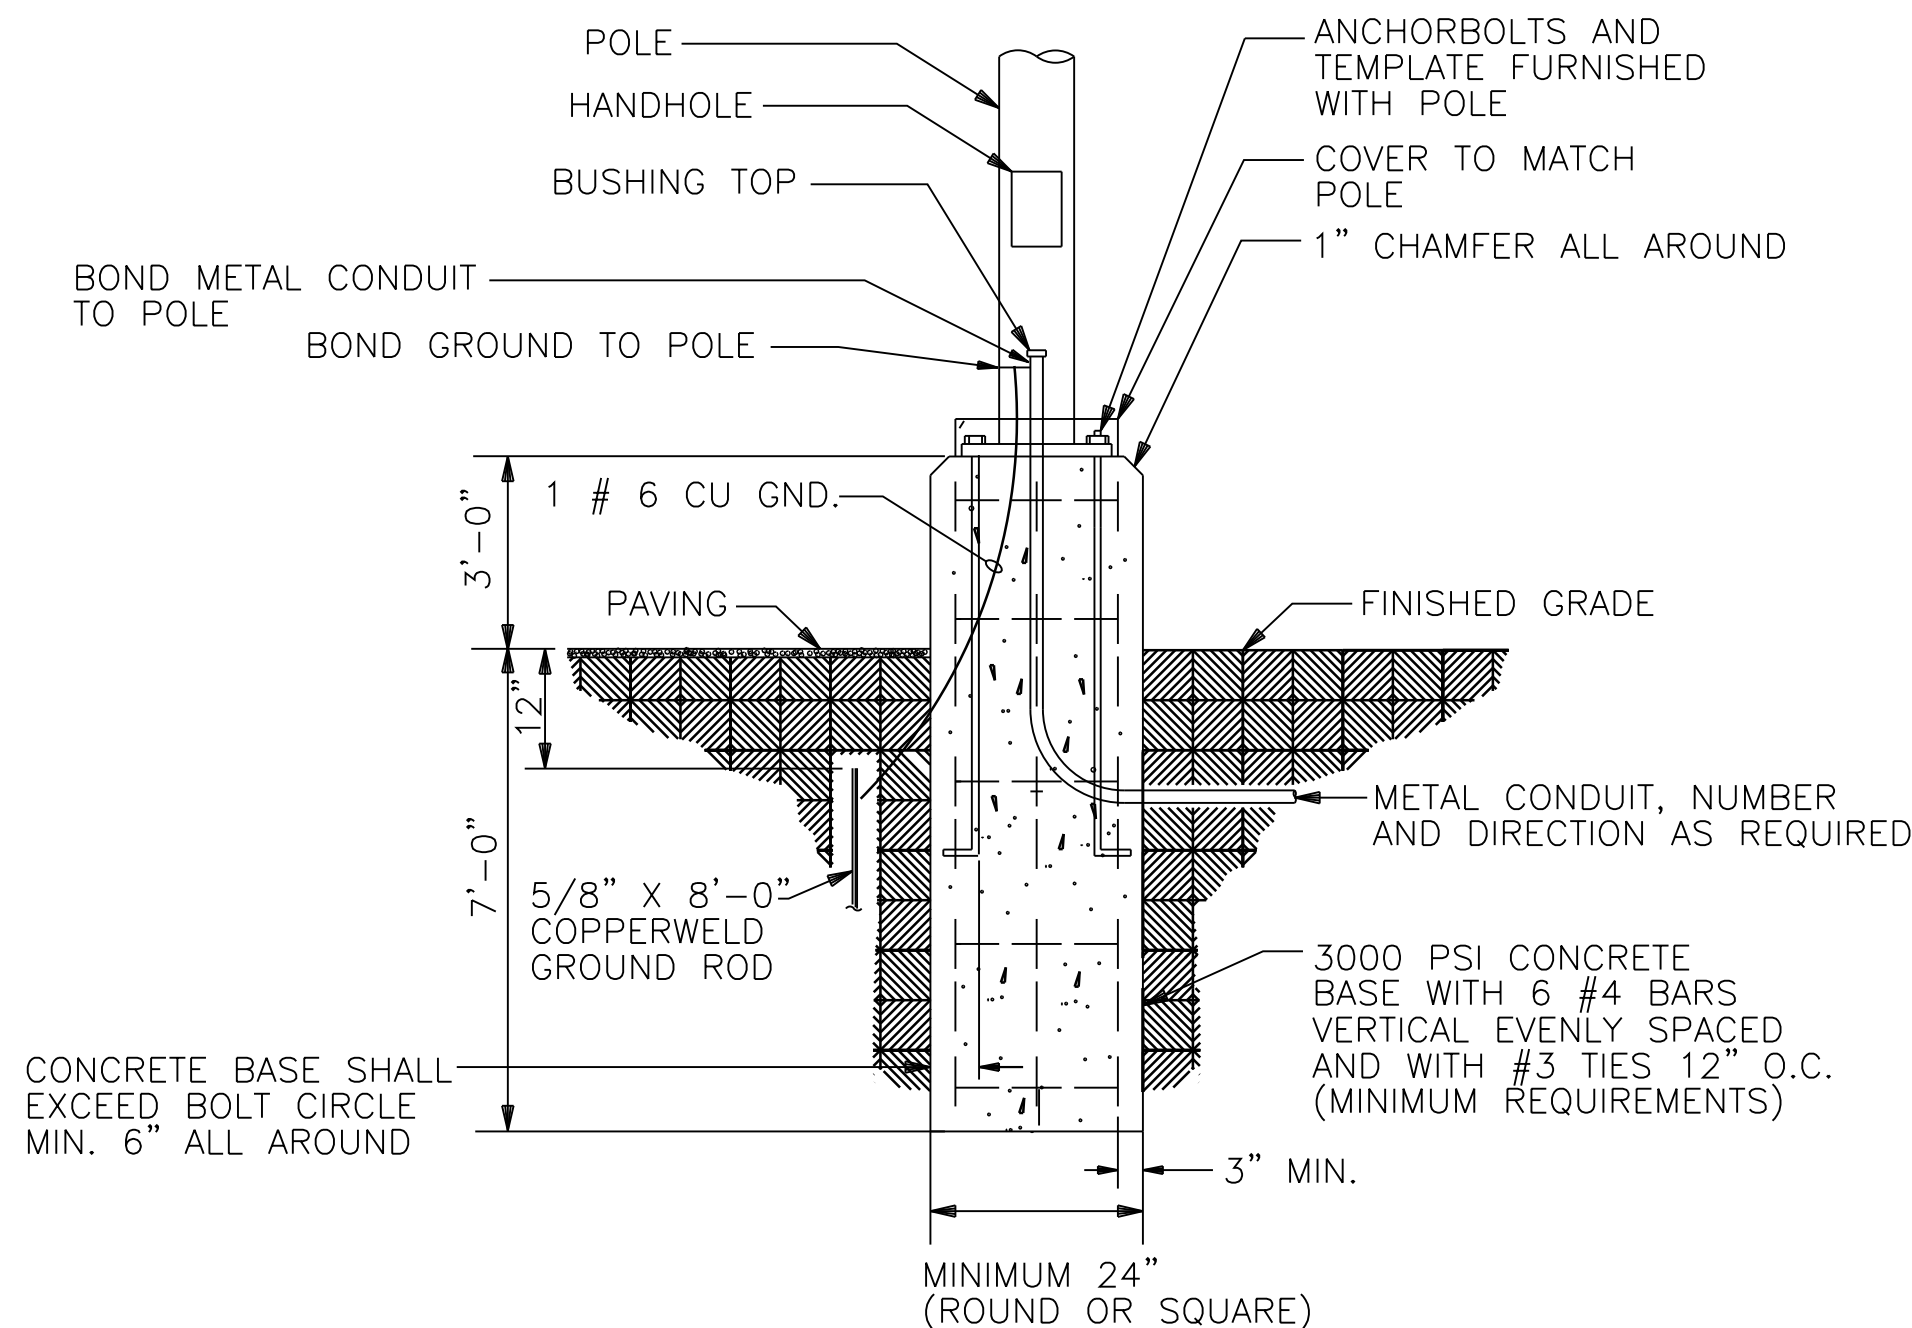

4 EXTENDED POLE BASE DETAIL - TYPE MA FIXTURE  
E 9.1.1 SCALE: NONE

DETAIL NOTES:


- POLE AND BASE WITH LUMINAIRES SHALL BE RATED FOR 115 MPH WIND LOADING WITH 1.3 GUST FACTOR PER AASHTO LTS-2.
- POLE AND BASE SHALL BE DESIGNED AND RATED FOR SITE SEISMIC CONDITIONS. SEE STRUCTURAL GENERAL NOTES FOR CRITERIA.
- PROVIDE IN-LINE WATERPROOF FUSE HOLDERS WITH 10AMP FUSES (OR OTHER SIZE AS RECOMMENDED BY LUMINAIRE MANUFACTURER) IN HANDHOLE IN PHASE CONDUCTORS TO LUMINAIRES. FUSE HOLDERS SHALL BE RATED 30AMP, 600V, DOUBLE POLE, EQUAL TO BUSS "TRON SERIES" MODEL HEX.
- ANCHORBOLTS SHALL EXTEND 11/2" ABOVE TOP OF CONCRETE BASE.

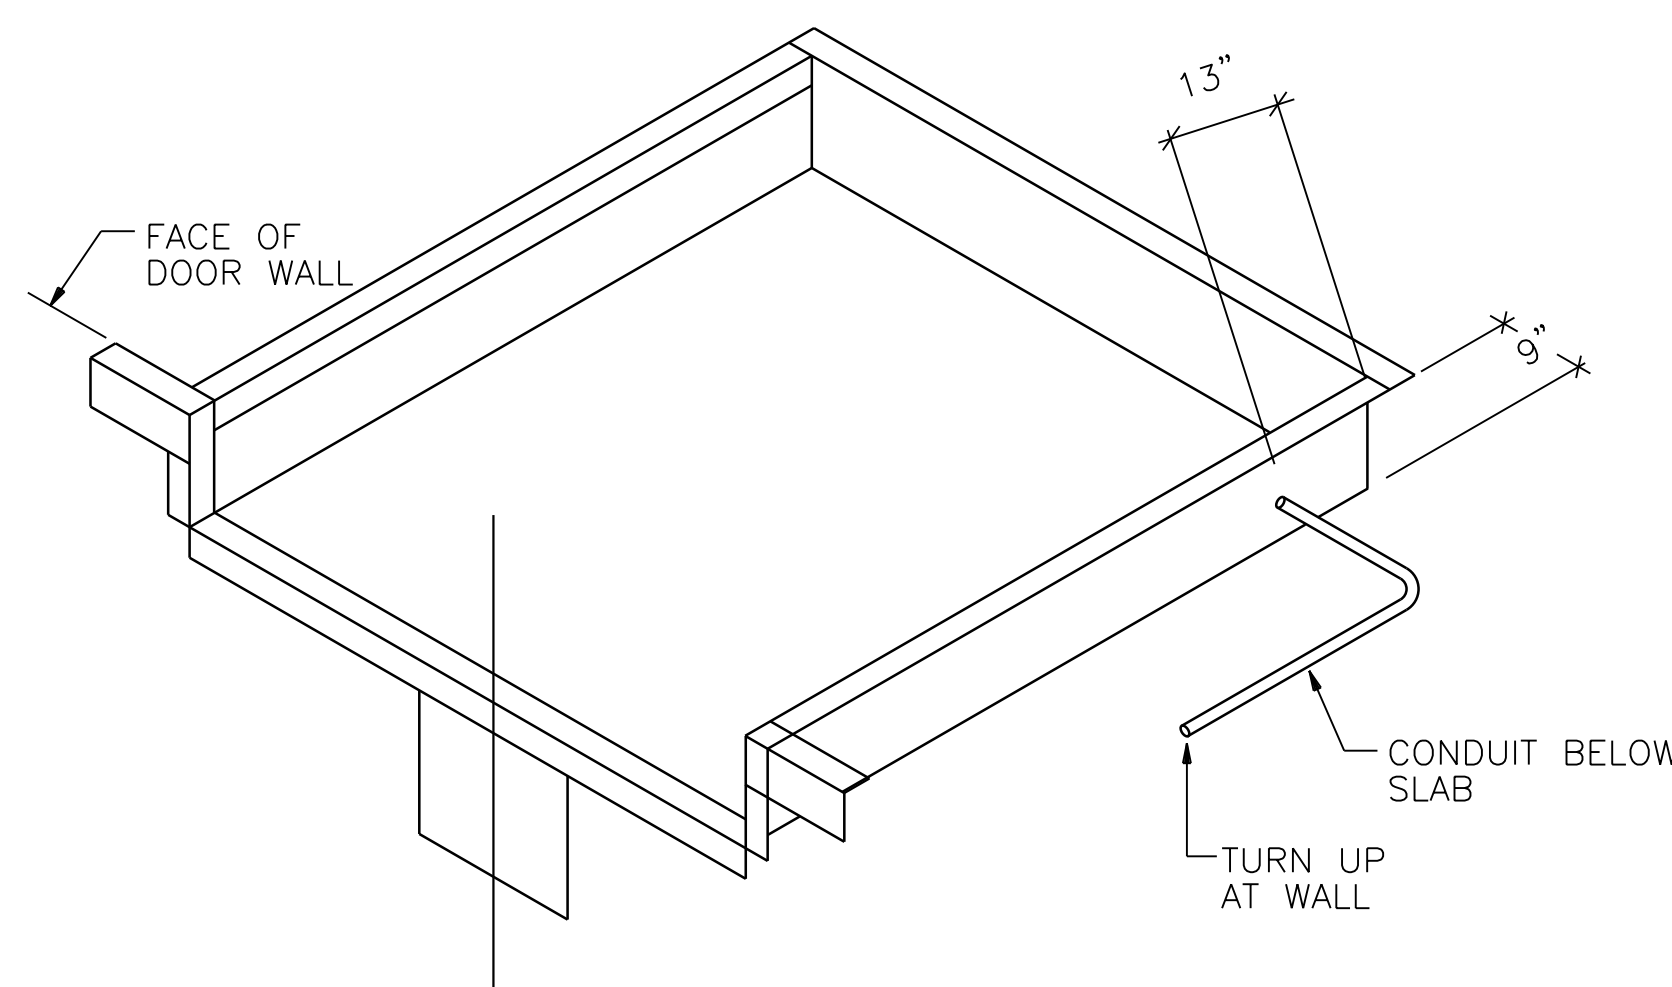

6 DOCK LEVELER PIT CONNECTION DETAIL  
E 9.1.1 SCALE: NONE

DETAIL NOTES:


- COORDINATE DIMENSIONS AND LOCATIONS OF CONDUIT WITH MANUFACTURER'S EQUIPEMTN TO BE INSTALLED.

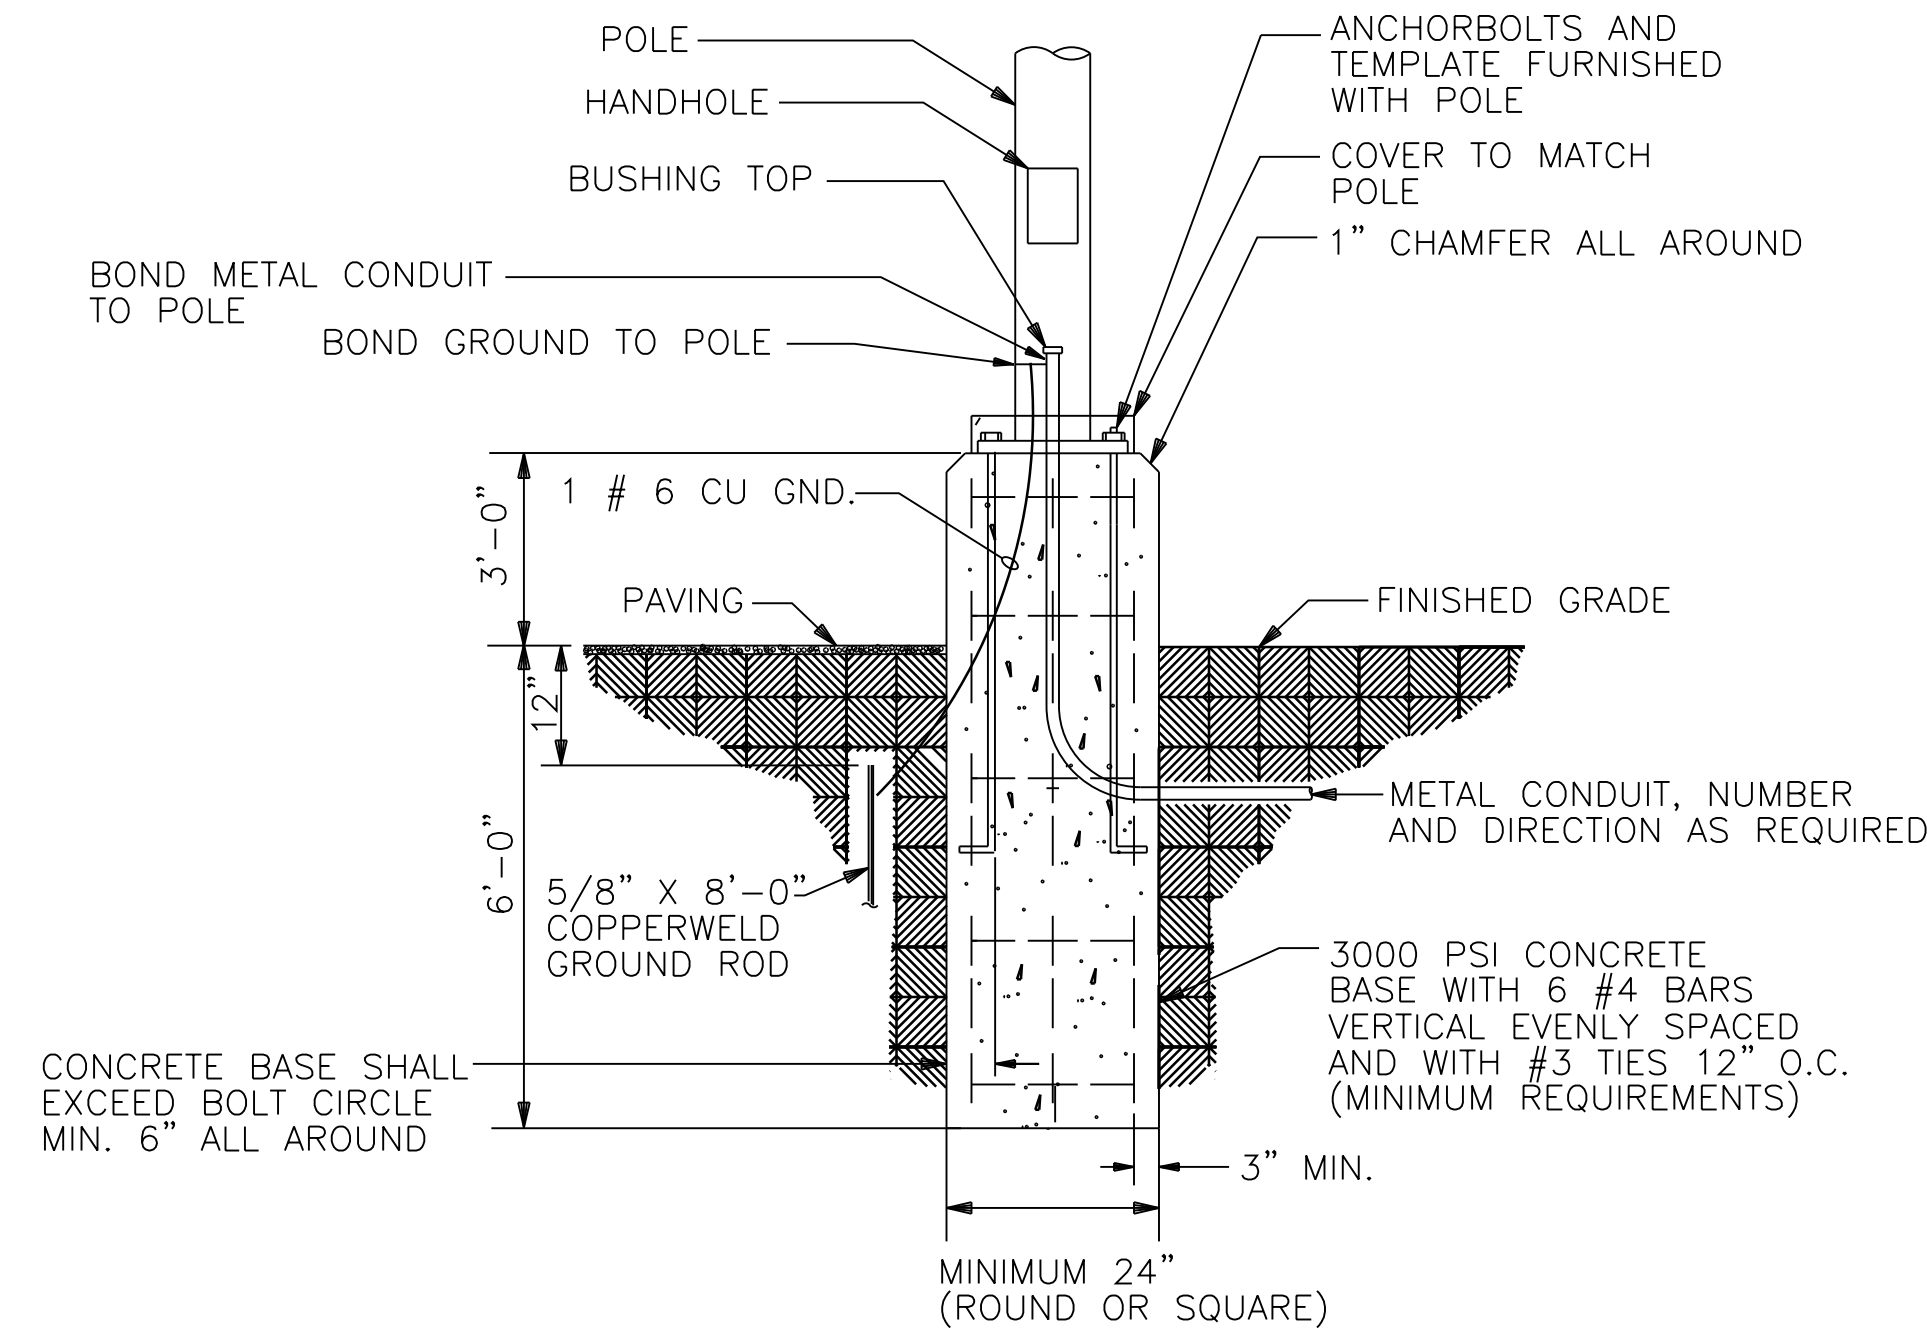

7 POLE BASE DETAIL - TYPE SA, SB SERIES FIXTURE  
E 9.1.1 SCALE: NONE

DETAIL NOTES:


- POLE AND BASE WITH LUMINAIRES SHALL BE RATED FOR 115 MPH WIND LOADING WITH 1.3 GUST FACTOR PER AASHTO LTS-2.
- POLE AND BASE SHALL BE DESIGNED AND RATED FOR SITE SEISMIC CONDITIONS. SEE STRUCTURAL GENERAL NOTES FOR CRITERIA.
- PROVIDE IN-LINE WATERPROOF FUSE HOLDERS WITH 10AMP FUSES (OR OTHER SIZE AS RECOMMENDED BY LUMINAIRE MANUFACTURER) IN HANDHOLE IN PHASE CONDUCTORS TO LUMINAIRES. FUSE HOLDERS SHALL BE RATED 30AMP, 600V, DOUBLE POLE, EQUAL TO BUSS "TRON SERIES" MODEL HEX.
- ANCHORBOLTS SHALL EXTEND 11/2" ABOVE TOP OF CONCRETE BASE.

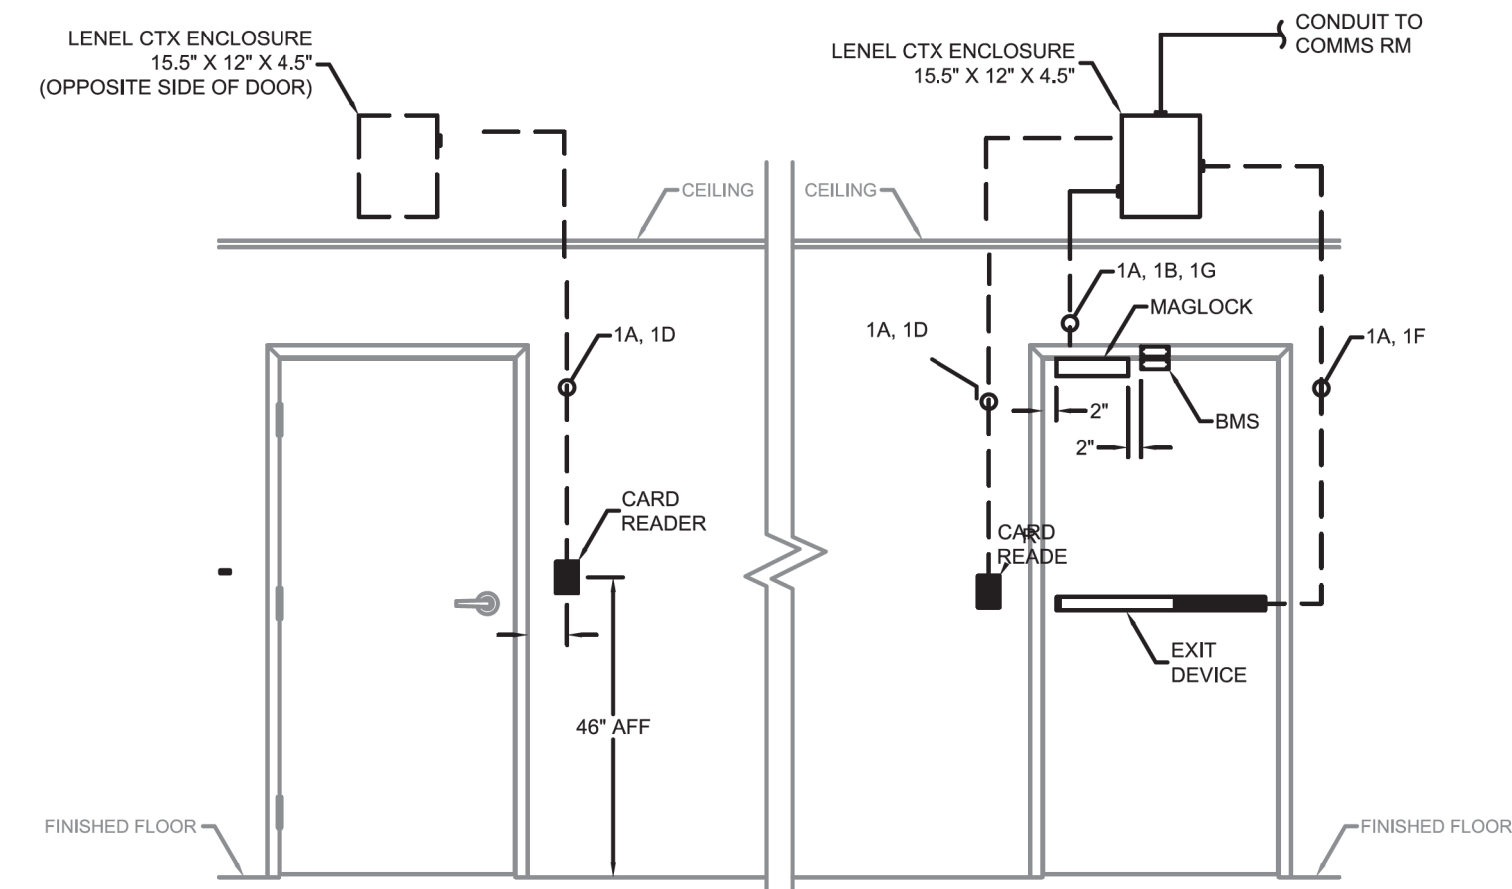

8 CARD READER HARDWARE DOOR DETAIL HW29C  
E 9.1.1 SCALE: NONE

DETAIL NOTES:


- DIV 26 CONTRACTOR SHALL BE REASONABLE TO PROCURE ALL DEVICES, BOXES AND WIRE FROM DOA SECURITY VENDOR EXCEPT FOR PANIC HARDWARE EXIT DEVICE, WHICH WILL BE FURNISHED WITH DOOR. INSTALLATION SHALL BE UNDER THE SCOPE OF THIS CONTRACT BY DOA SECURITY VENDOR.

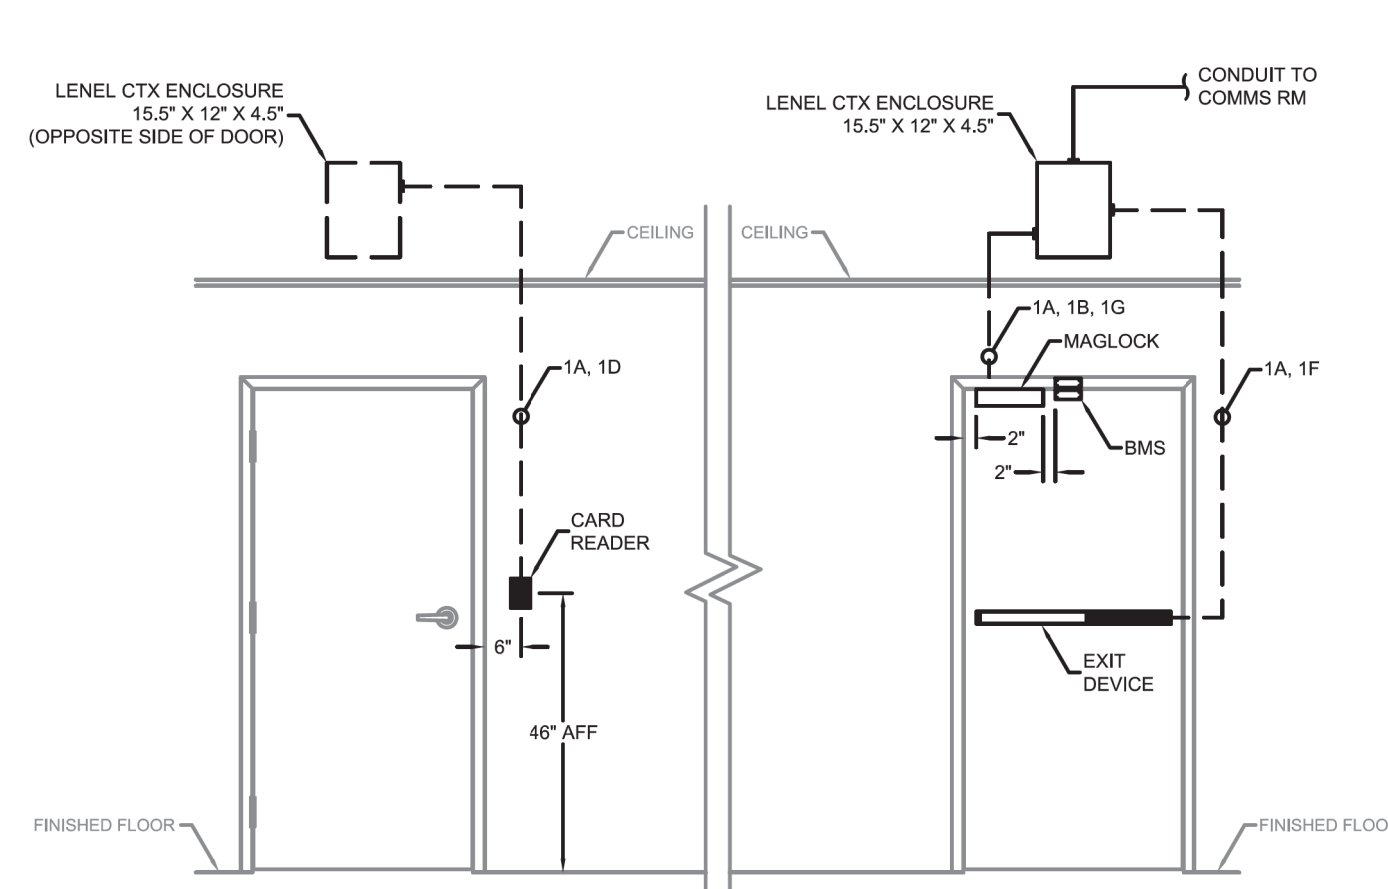

9 CARD READER HARDWARE DOOR DETAIL HW29B  
E 9.1.1 SCALE: NONE

DETAIL NOTES:

- DIV 26 CONTRACTOR SHALL BE REASONABLE TO PROCURE ALL DEVICES, BOXES AND WIRE FROM DOA SECURITY VENDOR EXCEPT FOR PANIC HARDWARE EXIT DEVICE, WHICH WILL BE FURNISHED WITH DOOR. INSTALLATION SHALL BE UNDER THE SCOPE OF THIS CONTRACT BY DOA SECURITY VENDOR.

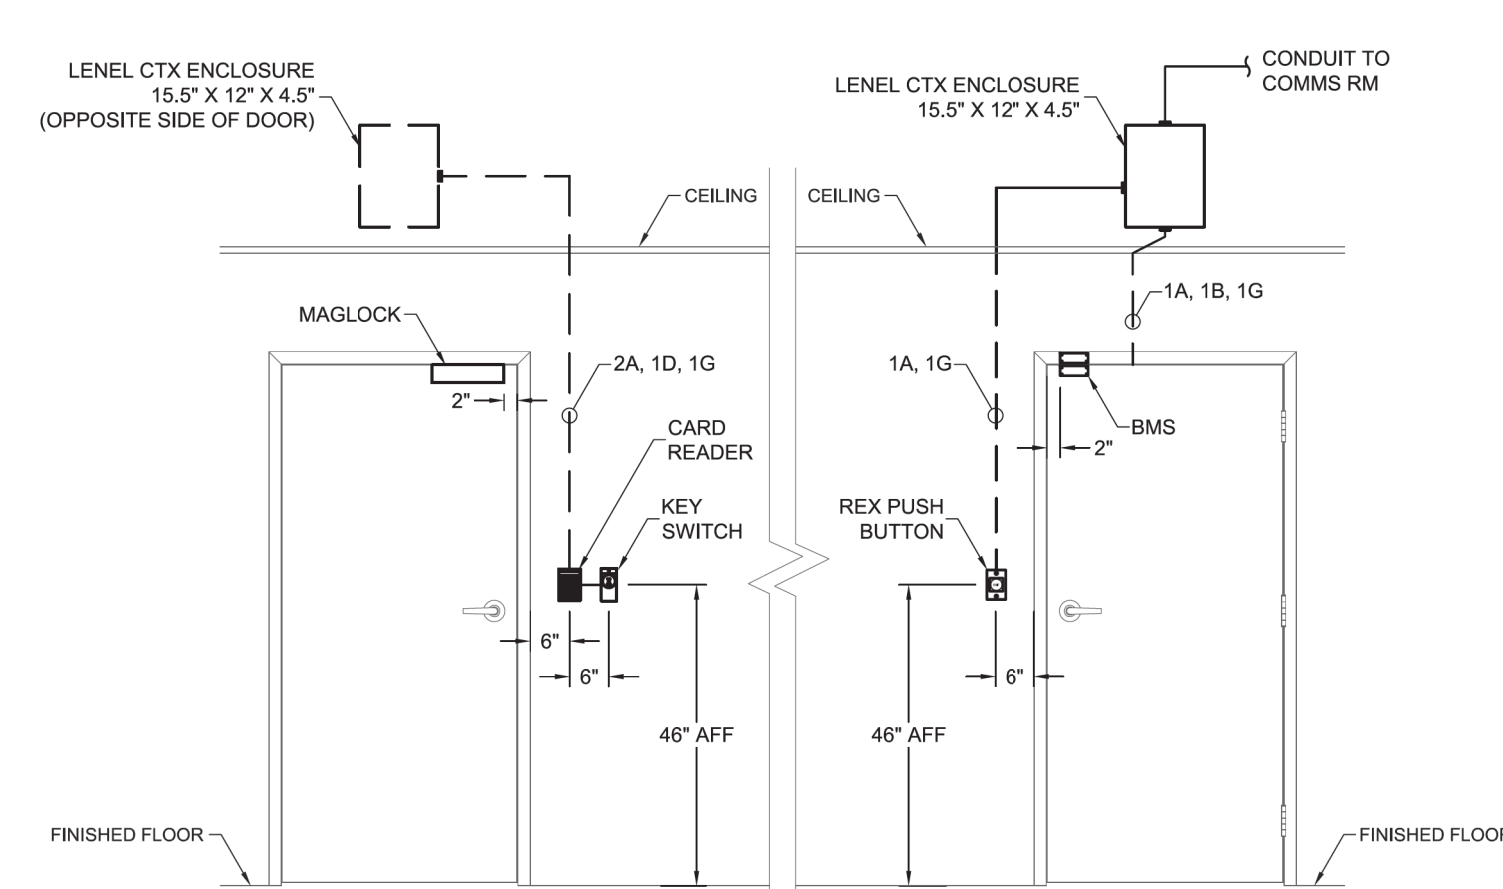

10 CARD READER HARDWARE DOOR DETAIL HW87  
E 9.1.1 SCALE: NONE

DETAIL NOTES:

- DIV 26 CONTRACTOR SHALL BE REASONABLE TO PROCURE ALL DEVICES, BOXES AND WIRE FROM DOA SECURITY VENDOR. INSTALLATION SHALL BE UNDER THE SCOPE OF THIS CONTRACT BY DOA SECURITY VENDOR.



CITY OF ATLANTA, GEORGIA

Hartsfield-Jackson  
Atlanta International Airport

**HSST**

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PEACHTREE STREET, NE  
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SOUTHEASTERN ENGINEERING, INC. (SEI)  
2015 SANDY PLAINS ROAD  
MARIETTA, GA 30066  
PHONE: 770.321.9508  
FAX: 770.321.3935

NO. DATE BY REVISION

AIR CARGO BUILDING C

ELECTRICAL  
DETAILS

WBS NUMBER:

D.07.55.009

FC NUMBER:

FC-6006007929-A

A/E PROJECT NUMBER:

HI-0730621

DRAWN BY:

M. TRINKER

DESIGNED BY:

M. TRINKER

CHECKED BY:

S. SVEDA

APPROVED BY:

S. SVEDA

DATE:

11/25/2014

SCALE:

NONE

SHEET NO.

E 9.1.1

SEAL

AIR CARGO BUILDING C, 100% CONSTRUCTION DOCUMENTS ISSUED FOR BID, NOVEMBER 25, 2014

NOT RELEASED FOR CONSTRUCTION